


STONE MOUNTAIN PATH - CLARKSTON

3648-3711 CHURCH STREET, CLARKSTON, GEORGIA 30021

EXHIBIT I

PROJECT SITE

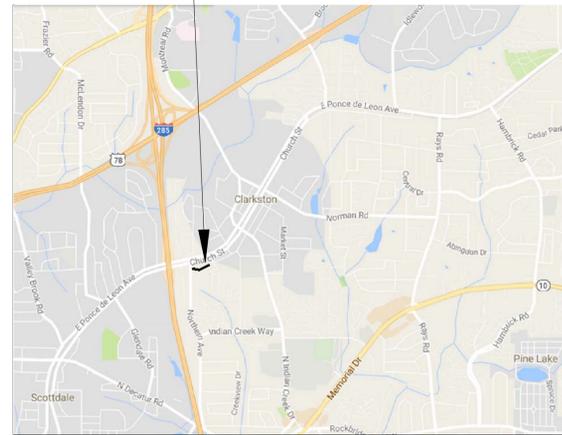

VICINITY MAP
N.T.S.

ALL WORK TO BE DONE IN ACCORDANCE WITH THE STANDARD SPECIFICATIONS OF THE DEPARTMENT OF TRANSPORTATION OF GEORGIA, 2016 EDITION, AND AS MODIFIED BY CONTRACT DOCUMENTS.

SURVEY AND COORDINATE DATA
 HORIZ. DATUM - GA. STATE PLANE COORDINATE SYSTEM
 VERT. DATUM - NAVD 1988
 COORDINATE ZONE - GEORGIA WEST
 PROJECT UNITS - ENGLISH

PROJECT DESCRIPTION

THE PROJECT FALLS WITHIN LAND LOTS 59 AND 60 IN DISTRICT 18. THE SITE IS ON CITY EASEMENTS AND CITY PROPERTY. THIS PROJECT WILL NOT REQUIRE ANY ZONING BUFFERS. THIS IS A TRAIL PROJECT WHICH IS BEING BUILT ON CITY PROPERTY - THEREFORE THE PROPOSED USE OF THE PROJECT IS CONSISTENT WITH ZONING. THE LIMITS OF DISTURBANCE IS APPROXIMATELY 0.49 ACRES.

NARRATIVE


THIS SITE IS A LINEAR CORRIDOR BEGINNING AT THE INTERSECTION OF CHURCH STREET AND MELL AVENUE, ALIGNING THROUGH CITY OWNED PROPERTY AND RIGHT-OF-WAY TO THE INTERSECTION OF LOVEJOY STREET AT ROWLAND STREET. THE PROJECT LENGTH IS APPROXIMATELY 831 LF WITH A 10'-11" WIDE CONCRETE TRAIL AND TRAIL AMENITIES. ADDITIONAL WORK ASSOCIATED WITH THE PROJECT INCLUDES MINOR DEMOLITION AND CLEARING, EROSION CONTROL, GRADING, STORM DRAINAGE, SIGNAGE AND STRIPING.

OWNER

CITY OF CLARKSTON
 1055 ROWLAND STREET
 CLARKSTON, GEORGIA 30021
 CONTACT: KEITH BARKER, CITY MANAGER
 404-296-6489

CONSTRUCTION MANAGEMENT

PATH FOUNDATION
 JONATHAN MCCAIG - 24 HOUR CONTACT
 GA GSWCC LEVEL 1 CERTIFICATION # 58893
 EXP. 08/21/2018
 office 404-875-7284 x5 cell 404-433-1900

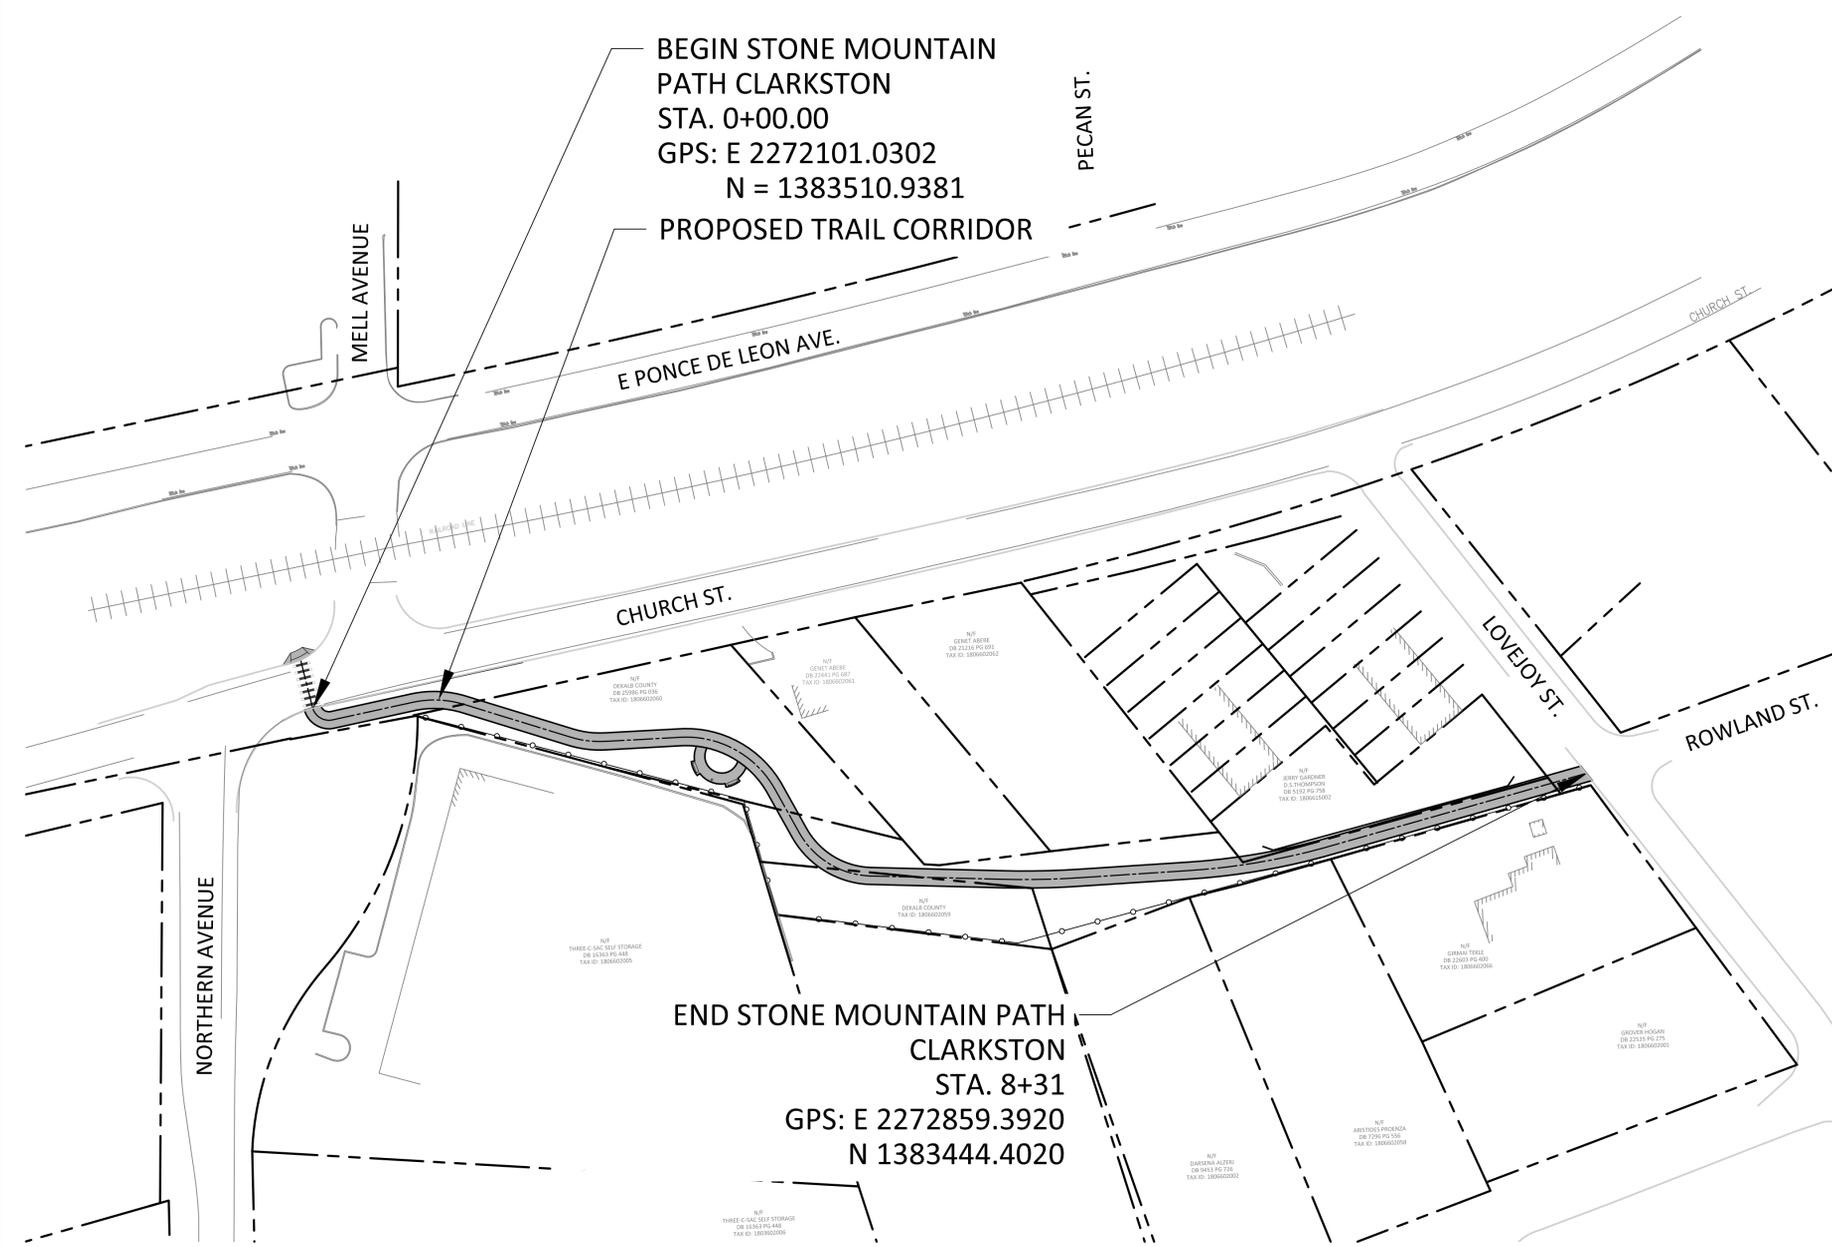

BOUNDARY AND TOPOGRAPHIC SURVEY INFORMATION PROVIDED BY:
 TRANSYSTEMS., (678)244-9733, AND BOUNDARY ZONE, INC., (404)446-8180.
 NO FIELD RUN SURVEY WAS CONDUCTED FOR THIS PARTICULAR SITE

ENGINEER'S CERTIFICATION STATEMENT:

With my initials at the line above and my seal and signature below, I Greta G. deMayo, a professional **Engineer, Architect or Landscape Architect** licensed in the **State of Georgia**, hereby certify that I have personally reviewed the attached submittal plans for a land disturbance permit. In my opinion these submittal plans meet all applicable regulations and ordinances of the City of Clarkston and other affected parties may rely on this certification.

Signed: *Greta G. deMayo* Georgia Registration # **NO. 1051**
 Date: **August 1, 2017**

TRAIL LENGTH **831LF**
 GROSS LENGTH OF PROJECT **831 LF**

TOTAL SITE AREA = 3.8 ACRES
 DISTURBED AREA = 0.49 ACRES

INDEX OF SHEETS


- GENERAL**
 COVER SHEET (THIS SHEET)
 GN-01 GENERAL NOTES
- TRAIL EASEMENT**
 SHEET01
 SHEET02
- TYPICAL SECTION**
 TS-01 TYPICAL SECTION
- CONSTRUCTION PLANS**
 CP-01 CONSTRUCTION PLAN
- SIGNING AND MARKING**
 SM-01 SIGNING AND MARKING
 SM-02 SIGNING AND MARKING
- CONSTRUCTION DETAILS**
 CD-01 CONSTRUCTION DETAILS
 CD-02 CONSTRUCTION DETAILS
- CIVIL AND EROSION CONTROL**
 EC-01 EROSION, SEDIMENTATION & POLLUTION CONTROL PLAN
 EC-02 EROSION, SEDIMENTATION & POLLUTION CONTROL PLAN
 EC-03 EROSION, SEDIMENTATION & POLLUTION CONTROL PLAN
 ECD-03 CONSTRUCTION DETAILS
 ECD-04 CONSTRUCTION DETAILS
 ECD-05 CONSTRUCTION DETAILS

PLANS PREPARED BY:

KAIZENCOLLABORATIVE

2390 Main Street | Tucker, GA 30084 | 404.239.2521


RUSSELL DAVIS & ASSOCIATES, INC.
 CIVIL ENGINEERING DESIGN

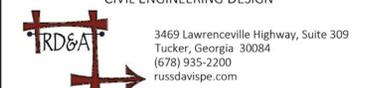

3469 Lawrenceville Highway, Suite 309
 Tucker, Georgia 30084
 (678) 935-2200
 russdavispe.com



GRAPHIC SCALE

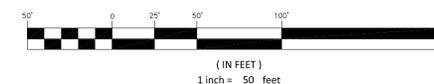


STONE MOUNTAIN PATH - CLARKSTON

KAIZEN PROJ # 2016-104

08/14/2017 - REV 1 - ISSUE FOR CONSTRUCTION

PROJECT SITE

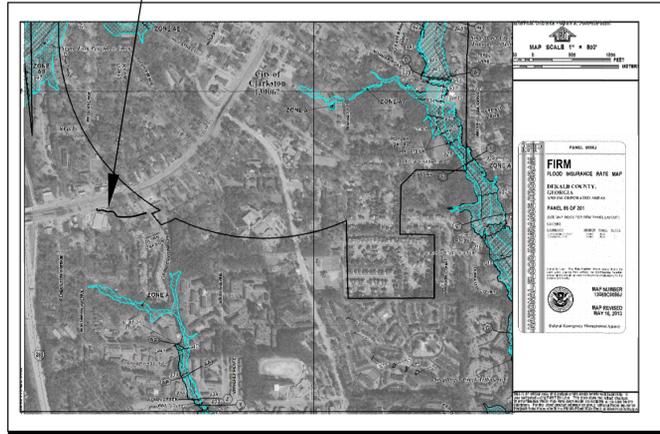

NOTE:
THE PROJECT IS NOT WITHIN THE FEMA 100 YEAR FLOOD HAZARD ZONE.

SITE DATA

TOTAL SITE AREA = 3.8 ACRES
DISTURBED AREA = 0.49 ACRES

NPDES FEE = 0.49 ACRES X \$6.00
(NO FEE IF UNDER 1 ACRE)

LAND LOT: 59, 60 of the 18th District

CONTACTS

PATH FOUNDATION
JONATHAN McCAIG - 24 HOUR CONTACT
GA GSWCC LEVEL 1 CERTIFICATION # 58893
EXP. 08/21/2018
office 404-875-7284 x5 cell 404-433-1900

EROSION & SEDIMENT CONTROL

1. THE ESCAPE OF SEDIMENT FROM THE SITE SHALL BE PREVENTED BY THE INSTALLATION OF EROSION AND SEDIMENT CONTROL MEASURES AND PRACTICES PRIOR TO, OR CONCURRENT WITH, LAND DISTURBANCE ACTIVITIES.
2. EROSION CONTROL MEASURES WILL BE MAINTAINED AT ALL TIMES. IF FULL IMPLEMENTATION OF THE APPROVED PLAN DOES NOT PROVIDE FOR EFFECTIVE EROSION CONTROL, ADDITIONAL EROSION AND SEDIMENT CONTROL MEASURES SHALL BE IMPLEMENTED TO CONTROL OR TREAT THE SEDIMENT SOURCE.
3. ANY DISTURBED AREA LEFT EXPOSED FOR A PERIOD GREATER THAN 14 DAYS SHALL BE STABILIZED WITH MULCH OR TEMPORARY SEEDING.
4. ADDITIONAL EROSION AND SEDIMENT CONTROL MEASURES AND PRACTICES WILL BE INSTALLED IF DEEMED NECESSARY BY THE ON-SITE INSPECTOR.
5. EROSION AND SEDIMENT MEASURES AND PRACTICES TO BE INSPECTED DAILY.
6. ALL INSPECTION, MONITORING, AND REPORTING SHALL BE PERFORMED AS REQUIRED BY NPDES PERMIT AND BY PROJECT EROSION, SEDIMENTATION, AND POLLUTION CONTROL NOTES.

(SEE EROSION CONTROL SHEETS FOR EROSION CONTROL CONSTRUCTION SCHEDULE)

DESCRIPTION	MONTH											
	1	2	3	4	5	6	7	8	9	10	11	12
SEDIMENT CONTROL												
CLEARING & GRUBBING												
GRADING												
TEMPORARY GRASSING												
PERMANENT GRASSING												
PAVING												
MAINT. OF EROSION CONTROL DEVICES												
BUILDING CONSTRUCTION												
DISPOSITION OF SEDIMENT DEVICES												
CLEARING OF STORM DRAINS												

ACTIVITY SCHEDULE

GENERAL NOTES

1. THE CONTRACTOR IS RESPONSIBLE FOR VERIFYING DIMENSIONS SHOWN HEREON WITH THE ARCHITECTURAL DRAWINGS AND EXISTING BUILDINGS PRIOR TO ANY CONSTRUCTION AND SHALL PROMPTLY NOTIFY THE PROJECT LANDSCAPE ARCHITECT OF ANY DISCREPANCIES.
2. PROPOSED CONTOURS AND SPOT ELEVATIONS REPRESENT FINAL GRADE. PROPOSED GRADE ELEVATIONS SHOWN WITHIN PAVED AREA REPRESENT TOP OF PAVEMENT ELEVATIONS. CONTRACTOR SHALL ALLOW FOR PAVEMENT THICKNESS, TOPSOIL, BASE COURSE, SLABS, ETC. WHEN GRADING TO SUBGRADE ELEVATIONS
3. DIMENSIONS ARE TO FACE OF CURB, CENTER OF STRUCTURE AND CENTER LINE OF COLUMN LINE, UNLESS OTHERWISE NOTED. ANGLES SHOWN ON STORM AND SANITARY SEWER ARE TO CENTER OF PIPE, UNLESS OTHERWISE NOTED.
4. **CALL BEFORE YOU DIG 811.** THE LOCATIONS OF EXISTING UTILITIES ARE APPROXIMATE AND SHALL BE VERIFIED BY THE CONTRACTOR PRIOR TO BEGINNING CONSTRUCTION. BEWARE OF HIDDEN UTILITIES NOT SHOWN. CONTRACTOR SHALL BE RESPONSIBLE FOR CONTACTING APPROPRIATE UTILITY COMPANIES PRIOR TO EXCAVATION. IF UNCHARTED UTILITIES ARE ENCOUNTERED DURING EXCAVATION OPERATIONS, THE CONTRACTOR SHALL NOTIFY THE PROJECT LANDSCAPE ARCHITECT IMMEDIATELY FOR INSTRUCTIONS. ANY DAMAGE OR INTERRUPTION OF EXISTING UTILITIES SHALL BE THE SOLE RESPONSIBILITY OF THE CONTRACTOR AND SHALL BE REPAIRED PROMPTLY AT THE CONTRACTOR'S EXPENSE.
5. PRIOR TO COMMENCING LAND DISTURBANCE ACTIVITY, THE LIMITS OF LAND DISTURBANCE SHALL BE CLEARLY AND ACCURATELY DEMARCATED WITH STAKES, RIBBONS, OR OTHER APPROPRIATE MEANS. THE LOCATION AND EXTENT OF ALL AUTHORIZED DISTURBANCE SHALL BE DEMARCATED FOR THE DURATION OF THE CONSTRUCTION ACTIVITY. NO DISTURBANCE SHALL OCCUR OUTSIDE THE LIMITS INDICATED ON THE DRAWINGS WITHOUT APPROVAL IN WRITING FROM THE PROJECT LANDSCAPE ARCHITECT.
6. THROUGHOUT CONSTRUCTION, THE CONTRACTOR SHALL PROVIDE AND MAINTAIN SUFFICIENT BARRICADES, LIGHTS, WARNING SIGNS, AND OTHER TRAFFIC CONTROL METHODS ADJACENT TO EXISTING ROADWAYS AND PARKING AREAS AS MAY BE REQUIRED FOR THE PROTECTION AND SAFETY OF THE PUBLIC. ALL TRAFFIC CONTROL MEASURES UTILIZED WITHIN PUBLIC RIGHT-OF-WAY SHALL COMPLY WITH MANUAL FOR UNIFORM TRAFFIC CONTROL DEVICES (MUTCD), CURRENT EDITION.
7. THE CONTRACTOR SHALL BE RESPONSIBLE FOR THE LAYOUT OF ALL CONSTRUCTION ELEMENTS, WITH SOME FIELD ADJUSTMENTS AS NECESSARY BY THE PROJECT LANDSCAPE ARCHITECT. IN ADDITION, THE CONTRACTOR SHALL BE RESPONSIBLE FOR INSURING THAT TRAIL AND AMENITY CONSTRUCTION COMPLIES WITH AASHTO REQUIREMENTS, PARTICULARLY WITH RESPECT TO TRAIL CROSS-SLOPES AND GRADIENTS.
8. THE CONTRACTOR SHALL BE RESPONSIBLE FOR TEMPORARY AND PERMANENT GROUNDWATER CONTROL DURING CONSTRUCTION, AS WELL AS PROVISIONS FOR CONTROLLING SURFACE WATER RUN-OFF, IN ORDER TO PREVENT PONDING IN OPEN EXCAVATIONS AND POTENTIAL UNDERMINING OF PERMANENT CONSTRUCTION FEATURES.
9. EARTHWORK OPERATIONS AND SOIL COMPACTION SHALL BE PERFORMED IN STRICT ACCORDANCE WITH THE PROJECT SPECIFICATIONS AND DRAWINGS. PRIOR TO POURING CONCRETE, EARTHWORK SHALL BE CLEAR OF DEBRIS AND MACHINE COMPACTED. CONSTRUCTION ACTIVITIES SHALL BE MONITORED BY A GEOTECHNICAL CONSULTING FIRM APPROVED BY THE OWNER TO VERIFY THAT EARTHWORK, WALL CONSTRUCTION, AND OTHER OPERATIONS CONFORM WITH THE CONTRACT DOCUMENTS. GEOTECHNICAL SERVICES SHALL BE AT THE COST OF THE CONTRACTOR.
10. THE TOPOGRAPHIC SURVEY INFORMATION HAS BEEN PROVIDED BY TRANSYSTEMS., (678)244-9733, AND BOUNDARY ZONE, INC., (404)446-8180, AND IS REFERENCED TO THE GEORGIA STATE PLANE COORDINATE SYSTEM (WEST ZONE). NO FIELD RUN SURVEY WAS CONDUCTED FOR THIS PARTICULAR SITE.
11. DEMOLITION DEBRIS SHALL BECOME PROPERTY OF THE CONTRACTOR AND WASTE SOILS, VEGETATION, AND OTHER DELETERIOUS MATERIALS SHALL BE HAULED OFF-SITE AND BE DISPOSED OF AT AN APPROVED LOCATION IN ACCORDANCE WITH LOCAL, STATE, AND FEDERAL REGULATIONS. BURNING WILL NOT BE ALLOWED ON THIS PROJECT.
12. EROSION CONTROL MEASURES AND OTHER SITE ISSUES SHALL BE INSPECTED REGULARLY BY CONTRACTOR.
13. ON ALL AREAS WHERE ROADWAYS, CONCRETE TRAILS, RETAINING WALLS, OR OTHER STRUCTURES ARE TO BE CONSTRUCTED ON COMPACTED SUBGRADE, FOUNDATION SOILS SHALL BE REVIEWED AND APPROVED BY THE GEOTECHNICAL CONSULTING FIRM PRIOR TO THE PLACEMENT OF CONCRETE, AGGREGATE BASE, OR FILL MATERIALS.
14. CONSTRUCTION ACCESS POINTS ARE APPROXIMATE LOCATIONS AND MUST BE FIELD VERIFIED AND APPROVED BY PROJECT MANAGER.
15. ALL WORK TO BE DONE IN ACCORDANCE WITH THE STANDARD SPECIFICATIONS OF THE DEPARTMENT OF TRANSPORTATION OF GEORGIA, 2016 EDITION, AND AS MODIFIED BY CONTRACT DOCUMENTS.
16. ALL CONCRETE TO BE USED FOR THE CONSTRUCTION OF TRAILS TO BE CLASS 'A' CONCRETE.
17. CONTRACTOR SHALL SCHEDULE A PRE-CONSTRUCTION MEETING WITH PATH FOUNDATION, KAIZEN COLLABORATIVE AND CITY OF CLARKSTON PRIOR TO BEGINNING CONSTRUCTION.
18. CONTRACTOR TO CONTACT KAIZEN COLLABORATIVE FOR ALL CONSTRUCTION STAKING CAD DATA
19. CITY TO ISSUE A LAND DISTURBANCE PERMIT UPON APPROVAL OF THE DESIGN PLANS.
20. CITY POINT OF CONTACT IS LARRY KAISER; 404-909-5619; KAISER@CO-INFRA-SERVICES.COM
21. CONSTRUCTION ZONE TRAFFIC CONTROL SIGNAGE PLAN REQUIRED. CONTRACTOR TO COORDINATE WITH CITY OF CLARKSTON TRANSPORTATION / ENGINEERING PRIOR TO CONSTRUCTION.

TRAIL NOTES

1. THE CONTRACTOR IS RESPONSIBLE FOR MAINTAINING MINIMUM SLOPES ALONG THE TRAIL. THE SLOPES SHALL NOT EXCEED 5% PERCENT, UNLESS SPECIFICALLY NOTED.
2. THE LAYOUT OF THE TRAIL IS SHOWN IN RELATION TO THE BEST AVAILABLE INFORMATION. THE CONTRACTOR SHALL VERIFY THE LAYOUT WITH OWNER PRIOR TO CONSTRUCTION OF TRAIL.
3. THE CONTRACTOR IS RESPONSIBLE FOR CLEARING OR ALL UNDERSTORY VEGETATION WITHIN 10' FROM CENTERLINE OF TRAIL. CLEARING AREA MAY INCREASE WHERE INVASIVE PLANTS ARE LOCATED.
4. ALL SIGNING & MARKING SHALL BE IN ACCORDANCE WITH THE MANUAL ON UNIFORM TRAFFIC CONTROL DEVICES (MUTCD), LATEST EDITION.
5. ALL SIGNS TO BE FABRICATED USING DIRECT PRINTING PROCESS. ALL SIGN PANELS TO HAVE BLACK BACKS.

CONSTRUCTION NOTES

1. TRAIL BACKFILL DIRT SHALL BE CLEAN, COHESIVE CLAY OR SANDY CLAY FREE OF DEBRIS, ORGANICS, DELETERIOUS MATERIAL AND ROCKS GREATER THAN 1" DIAMETER.
2. MAX CUT OR FILL SLOPES SHALL BE 3:1 (H:V), UNLESS SPECIFICALLY NOTED.
3. EQUIPMENT AND MATERIALS SHALL BE STORED IN AREAS DESIGNATED BY THE OWNER. CONSTRUCTION AND STORAGE AREAS SHALL BE KEPT NEAT AND CLEAN. TREE SAVE AREAS SHALL NOT BE USED FOR STORAGE OR PARKING. EQUIPMENT AND MATERIAL SHALL NOT BE STORED WITHIN THE DRIP LINE OF TREES.
4. CONTRACTOR TO VERIFY THE ELEVATIONS OF ALL TIE-IN POINTS FOR INSTALLATION OF UTILITIES, CURB & GUTTER AND PAVING.
5. TRENCH BACKFILL MATERIAL SHALL BE COMPACTED TO NOT LESS THAN 95% OF THE OPTIMUM COMPACTION FOR ANY SOIL CLASSIFICATION AS DETERMINED BY THE STANDARD PROCTOR TEST AASHTO T-180 METHOD "A". BACKFILL MATERIAL SHALL BE CLEAN AND FREE OF ROOTS, ROCK OR DELETERIOUS MATTER. CONTRACTOR SHALL CORRECT ANY DAMAGE TO CURBING OR PAVING CAUSED BY TRENCH SETTLEMENT WHICH OCCURS WITHIN 12 MONTHS OF PROJECT ACCEPTANCE.
6. THE CONTRACTOR SHALL NOTIFY THE PROJECT LANDSCAPE ARCHITECT OF ANY DISCREPANCIES BETWEEN PLAN AND FIELD CONDITIONS PROMPTLY UPON DISCOVERY.
7. ALL EXISTING ELECTRICAL BOXES, WATER METER BOXES, AND VALVE BOXES, WHICH ARE TO REMAIN SHALL BE SET FLUSH WITH THE TOP OF THE PROPOSED GRADE.
8. AREAS INTENDED TO SUPPORT PAVEMENT OR NEW FILL SHALL BE PROOF ROLLED IN THE PRESENCE OF THE GEOTECHNICAL ENGINEER TO LOCATE WEAK, SOFT OR EXCESSIVELY WET MATERIALS. AREAS WHICH PUMP WHILE PROOF ROLLED SHALL BE UNDERCUT AND BACK-FILLED.
9. CRUSHED STONE AGGREGATE IN PAVEMENT BASE SHALL CONFORM WITH SECTION 815 OF THE STATE OF GEORGIA, DEPARTMENT OF TRANSPORTATION, STANDARD SPECIFICATIONS. ALL ASPHALT MATERIAL AND PAVING OPERATIONS SHALL MEET APPLICABLE SPECIFICATIONS OF THE GEORGIA DEPARTMENT OF TRANSPORTATION.
10. ALL FILL AREAS MUST BE COMPACTED TO A MINIMUM 95% STANDARD PROCTOR. A REPORT FROM A GEOTECHNICAL ENGINEER MAY BE REQUIRED BY THE CONSTRUCTION INSPECTOR FOR ALL FILL AREAS WITHIN THE RIGHT-OF-WAY.
11. CONTRACTOR SHALL ENSURE POSITIVE DRAINAGE ACROSS DISTURBED AREA AND INTO DRAINAGE FEATURES.

CONSTRUCTION LEGEND

- PROPOSED TRAIL
- PROPOSED STRUCTURAL SLAB BRIDGE CROSSINGS
- PROPOSED CROSSWALK
- LIMITS OF CONSTRUCTION
- PROPOSED FENCELINE
- EXISTING FENCELINE
- PROPOSED DEMOLITION
- EXISTING CONTOUR ELEVATION
- PROPOSED CONTOUR ELEVATION
- EXISTING DIRT ROAD
- PIPE AND CULVERT
- STEEL BOLLARDS
- SPOT ELEVATION
- SHEET MATCHLINE
- PROPERTY LINE
- LAND LOT LINE

LEGEND		
	1033 CATCH BASIN	
	1034 CATCH BASIN	
	1019A DROP INLET	
	1011A JUNCTION BOX	
	1019A TYPE E CURB INLET	
	1125 HEADWALL	
	DRAINAGE SLOPE	
	SEWER MANHOLE	
	EXISTING FIRE HYDRANT	
	PROPOSED FIRE HYDRANT	
	LAMP POST	
	GUY POLE	
	UTILITY POLE	

KAIZEN COLLABORATIVE
2390 Main Street | Tucker, GA 30084 | 404.239.2521

REVISION	DATE	DESCRIPTION
1	2017-08-14	CITY COMMENTS

KAIZEN PROJECT # 2016-104
PROJECT MANAGER GGD

**STONE MOUNTAIN PATH
CLARKSTON, GA**



GENERAL NOTES



DATE: AUG 1, 2017

SHEET NAME: **GN-01**




LEGEND:

- PROPERTY CORNER FOUND (AS NOTED)
- 1/2" REBAR WITH CAP SET LSF# 839
- R/W MONUMENT
- ⦿ FIRE HYDRANT
- ⊞ WATER METER
- ⊞ WATER VALVE
- ⊞ POWER POLE
- ⊞ LIGHT POLE
- ⊞ POWER/LIGHT POLE
- └ GUY WIRE
- ⊞ POWER METER
- ⊞ POWER BOX
- ⊞ A/C UNIT
- ⊞ MANHOLE
- ⊞ CLEAN OUT
- ⊞ CATCH BASIN
- ⊞ JUNCTION BOX
- ⊞ OUTFLOW STRUCTURE
- ⊞ DRAINAGE INLET
- ⊞ GAS METER
- ⊞ GAS VALVE
- ⊞ CABLE BOX
- ⊞ TELEPHONE BOX
- ⊞ SIGN
- W— WATER LINE
- U— OVERHEAD UTILITY LINE
- S— SEWER LINE
- G— GAS LINE
- C— CABLE LINE
- T— TELEPHONE LINE
- X— FENCE LINE
- 920- CONTOUR LINE
- BSL BUILDING SETBACK LINE
- CONC. CONCRETE
- EOP EDGE OF PAVEMENT
- L.L. LAND LOT
- N/F NOW OR FORMERLY
- P/L PROPERTY LINE
- R/W RIGHT-OF-WAY
- D.E. DRAINAGE EASEMENT
- O.H. OVERHANG
- CNT CANTILEVER
- DB DEED BOOK
- PB PLAT BOOK
- PG PAGE
- POB POINT OF BEGINNING
- POC POINT OF COMMENCEMENT

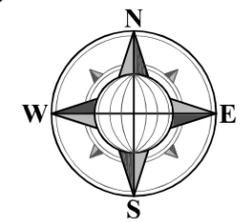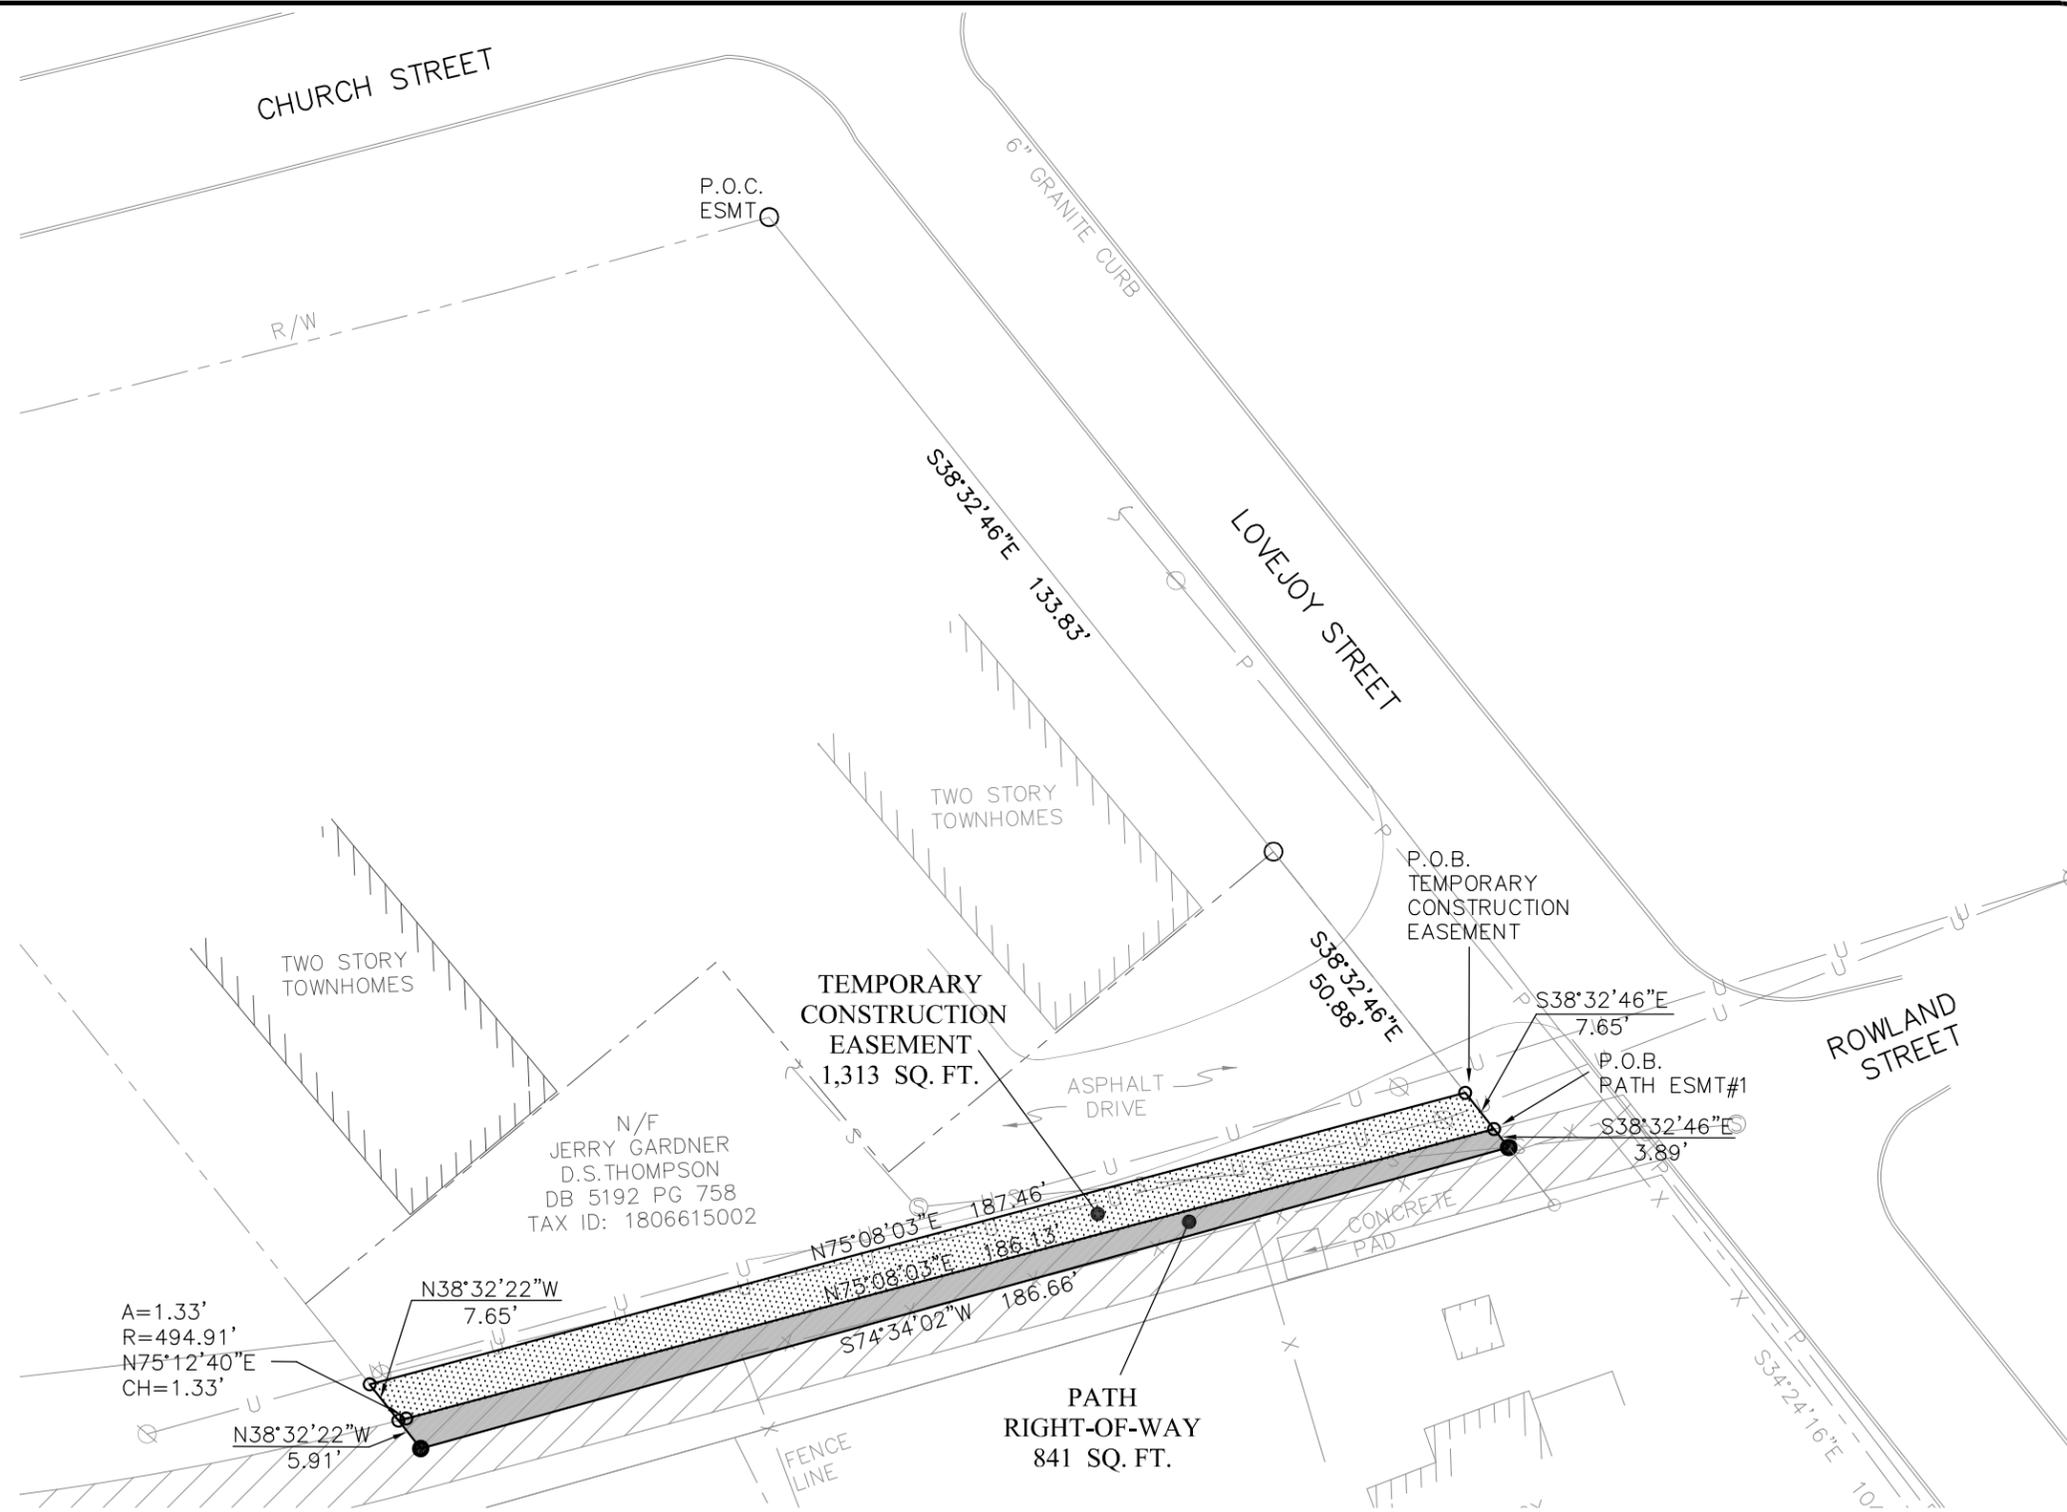

GRID NORTH
GA. WEST ZONE
NAD 1983
SCALE: 1"=30'

PATH RIGHT-OF-WAY
AND TEMPORARY CONSTRUCTION
EASEMENT EXHIBIT
PREPARED FOR: CITY OF CLARKSTON
TAX PARCEL: 1806615002
LAND LOT 66, 18TH DISTRICT
DEKALB COUNTY, GEORGIA - 06/12/2017

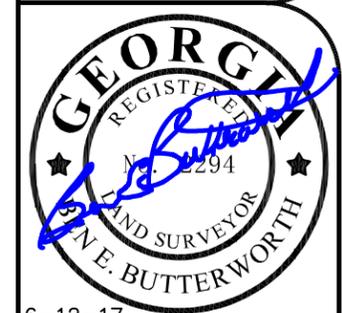

6-12-17
FOR THE FIRM
BOUNDARY ZONE, INC.
LSF #839
NOT VALID WITHOUT
ORIGINAL SIGNATURE

THIS SURVEY WAS MADE WITHOUT THE BENEFIT OF A CURRENT TITLE COMMITMENT. EASEMENTS AND ENCUMBRANCES MAY EXIST WHICH BENEFIT AND BURDEN THIS PROPERTY.

THIS PLAT WAS PREPARED FOR THE EXCLUSIVE USE OF THE PERSON, PERSONS OR ENTITY NAMED HEREON AND DOES NOT EXTEND TO ANY UNNAMED PERSON WITHOUT A RECERTIFICATION BY THE SURVEYOR NAMING SAID PERSON.

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BOUNDARY REFERENCE: PLAT BOOK 9, PAGE 118
FIELDWORK PERFORMED ON 06/09/2017

THIS MAP OR PLAT HAS BEEN CALCULATED FOR CLOSURE AND IS FOUND TO BE ACCURATE WITHIN ONE FOOT IN 183,313 FEET.

THIS PLAT HAS BEEN PREPARED USING A TRIMBLE 5603 ROBOTIC TOTAL STATION.

THE FIELD DATA UPON WHICH THIS PLAT IS BASED HAS A RELATIVE POSITIONAL ACCURACY OF 0.02 FEET.

BOUNDARY zone, inc. LAND SURVEYING SERVICES
LANDSCAPE ARCHITECTURE
LAND PLANNING


BUFORD
4195 SOUTH LEE STREET, SUITE 1
BUFORD, GEORGIA 30518

ATLANTA
235 PEACHTREE STREET NE, SUITE 400
ATLANTA, GEORGIA 30303

MARIETTA
1870 THE EXCHANGE, SUITE 100
MARIETTA, GA 30039

RALEIGH
2205-C CANDUN DRIVE, APEX
NORTH CAROLINA 27523

SURVEYING LANDSCAPE ARCHITECTURE LAND PLANNING
WWW.BOUNDARYZONE.COM (770) 271-5772 (919) 363-9226

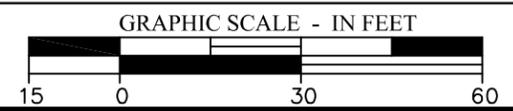


PROJECT
1848201

SHEET
1 OF 1

LEGEND:


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- P/L PROPERTY LINE
- OH OVERHANG
- C.B. CATCH BASIN
- CNT CANTILEVER
- H/C HANDICAP
- FFE FINISHED FLOOR ELEVATION
- BFE BASEMENT FLOOR ELEVATION
- GFE GARAGE FLOOR ELEVATION
- DB DEED BOOK
- PB PLAT BOOK
- PG PAGE
- POB POINT OF BEGINNING
- POC POINT OF COMMENCEMENT
- NAD NORTH AMERICAN DATUM
- NAVD NORTH AMERICAN VERTICAL DATUM
- ⊕ HARDWOOD TREE
- ⊕ PINE TREE

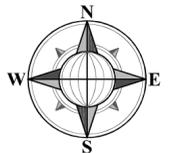

GRID NORTH
GA. WEST ZONE
NAD 1983

SCALE: 1" = 40'

**PATH RIGHT-OF-WAY
AND TEMPORARY CONSTRUCTION EASEMENT EXHIBIT
PREPARED FOR: CITY OF CLARKSTON
TAX PARCEL: 1806602003
LAND LOT 66, 18TH DISTRICT
DEKALB COUNTY, GEORGIA - 06/12/2017**

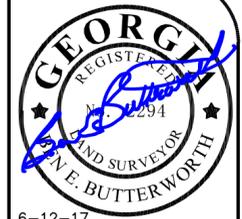

6-12-17
FOR THE FIRM
BOUNDARY ZONE, INC.
LSF #839
NOT VALID WITHOUT ORIGINAL SIGNATURE

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BOUNDARY REFERENCE: PLAT BOOK 9, PAGE 118 FIELDWORK PERFORMED ON 06/09/2017
THIS MAP OR PLAT HAS BEEN CALCULATED FOR CLOSURE AND IS FOUND TO BE ACCURATE WITHIN ONE FOOT IN 101,738 FEET.
THIS PLAT HAS BEEN PREPARED USING A TRIMBLE 5603 ROBOTIC TOTAL STATION.
THE FIELD DATA UPON WHICH THIS PLAT IS BASED HAS A RELATIVE POSITIONAL ACCURACY OF 0.02 FEET.

BOUNDARY zone, inc. LAND SURVEYING SERVICES
LANDSCAPE ARCHITECTURE
LAND PLANNING


SURVEYING LANDSCAPE ARCHITECTURE LAND PLANNING
WWW.BOUNDARYZONE.COM (770) 271-5772 (919) 363-9226

BUFORD
4195 SOUTH LEE STREET, SUITE 1
BUFORD, GEORGIA 30518

ATLANTA
235 PEACHTREE STREET NE, SUITE 400
ATLANTA, GEORGIA 30303


MARIETTA
1870 THE EXCHANGE, SUITE 100
MARIETTA, GA 30339

RALEIGH
2205-C CANDUN DRIVE, APEX
NORTH CAROLINA 27523

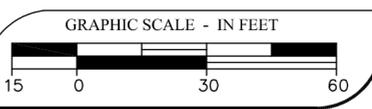

PROJECT
1848201


SHEET
1 OF 1

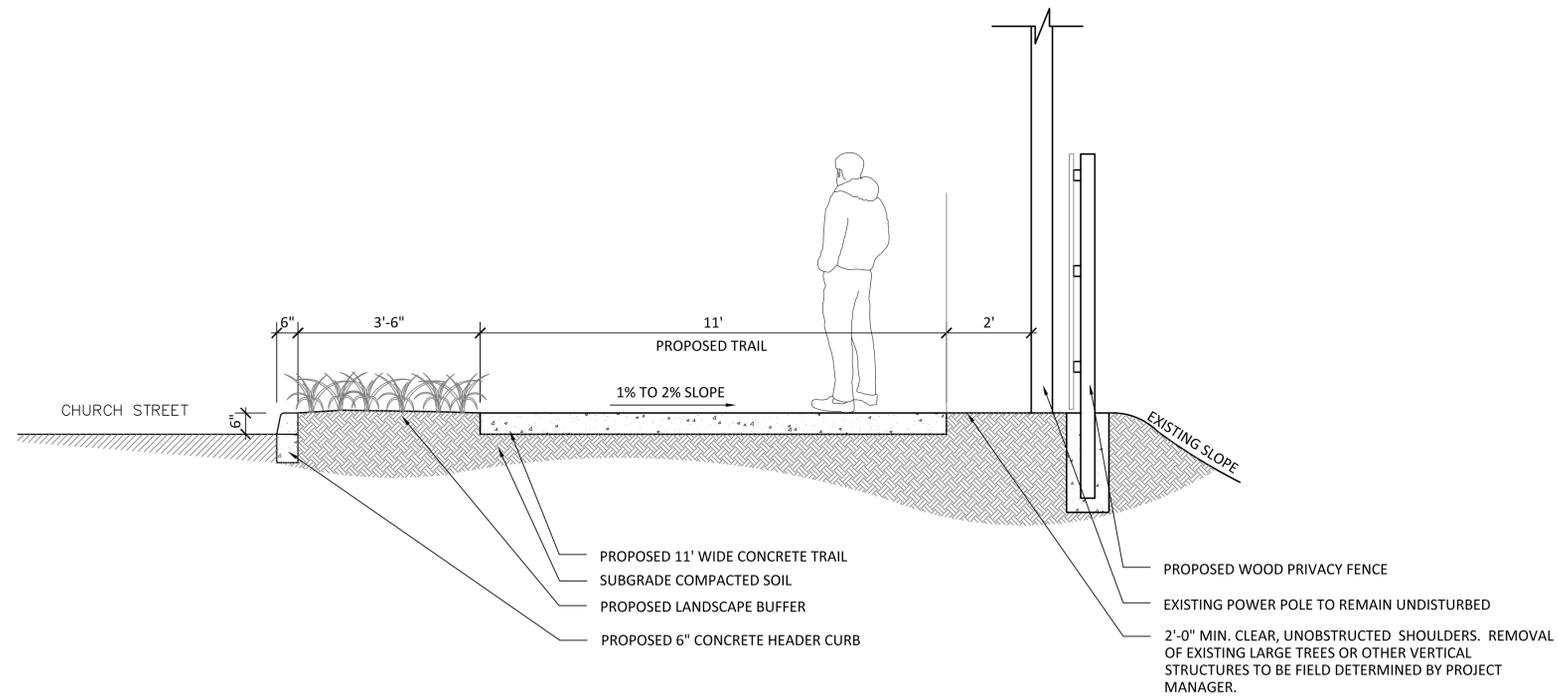

01
TS-01

TYPICAL SECTION

SCALE: 1/2" = 1'0"

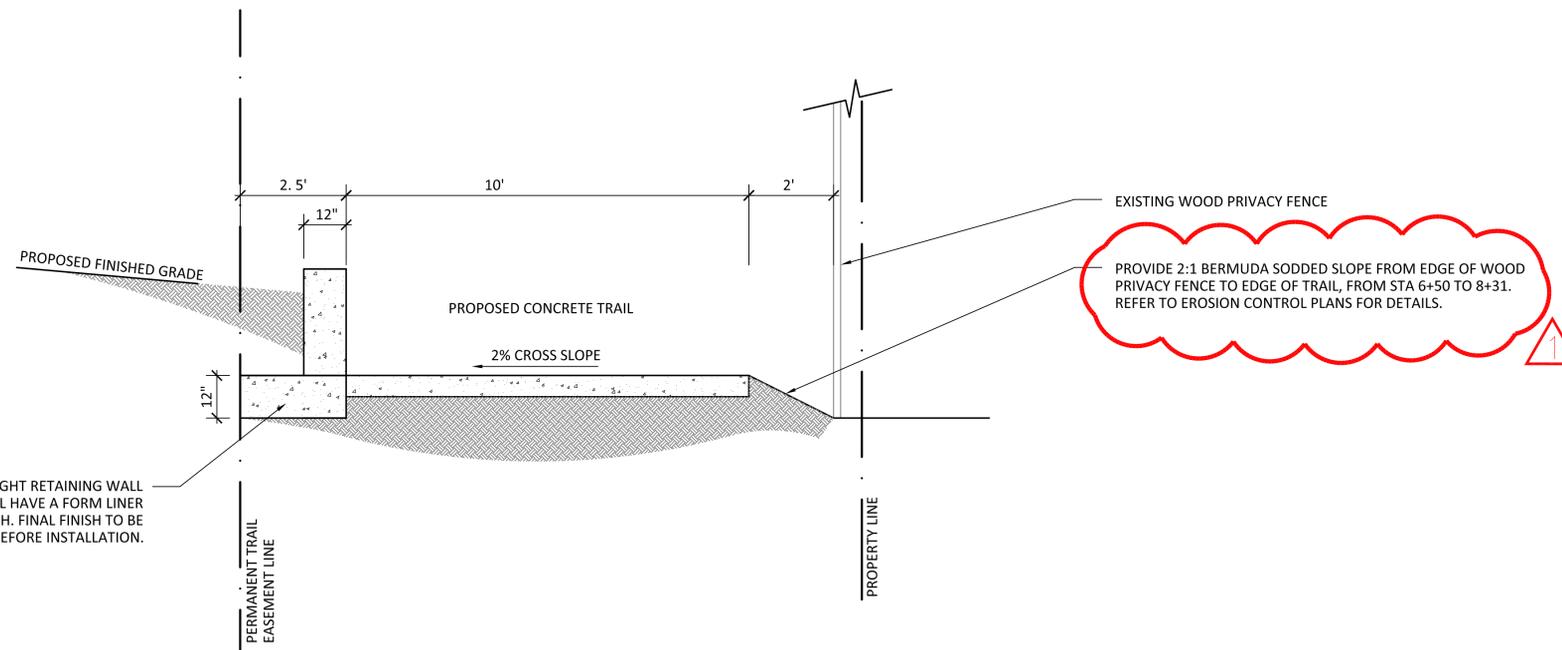

02
TS-01

TYPICAL SECTION

SCALE: 1/2" = 1'0"

KAIZENCOLLABORATIVE

2390 Main Street | Tucker, GA 30084 | 404.239.2521

REVISION	DATE	DESCRIPTION
1	2017-08-14	CITY COMMENTS

KAIZEN PROJECT # 2016 - 104
PROJECT MANAGER GGD

STONE MOUNTAIN PATH

CLARKSTON, GA




TYPICAL SECTIONS

SCALE: 1/2" = 1'


DATE: AUG 1, 2017

SHEET NAME: **TS-01**

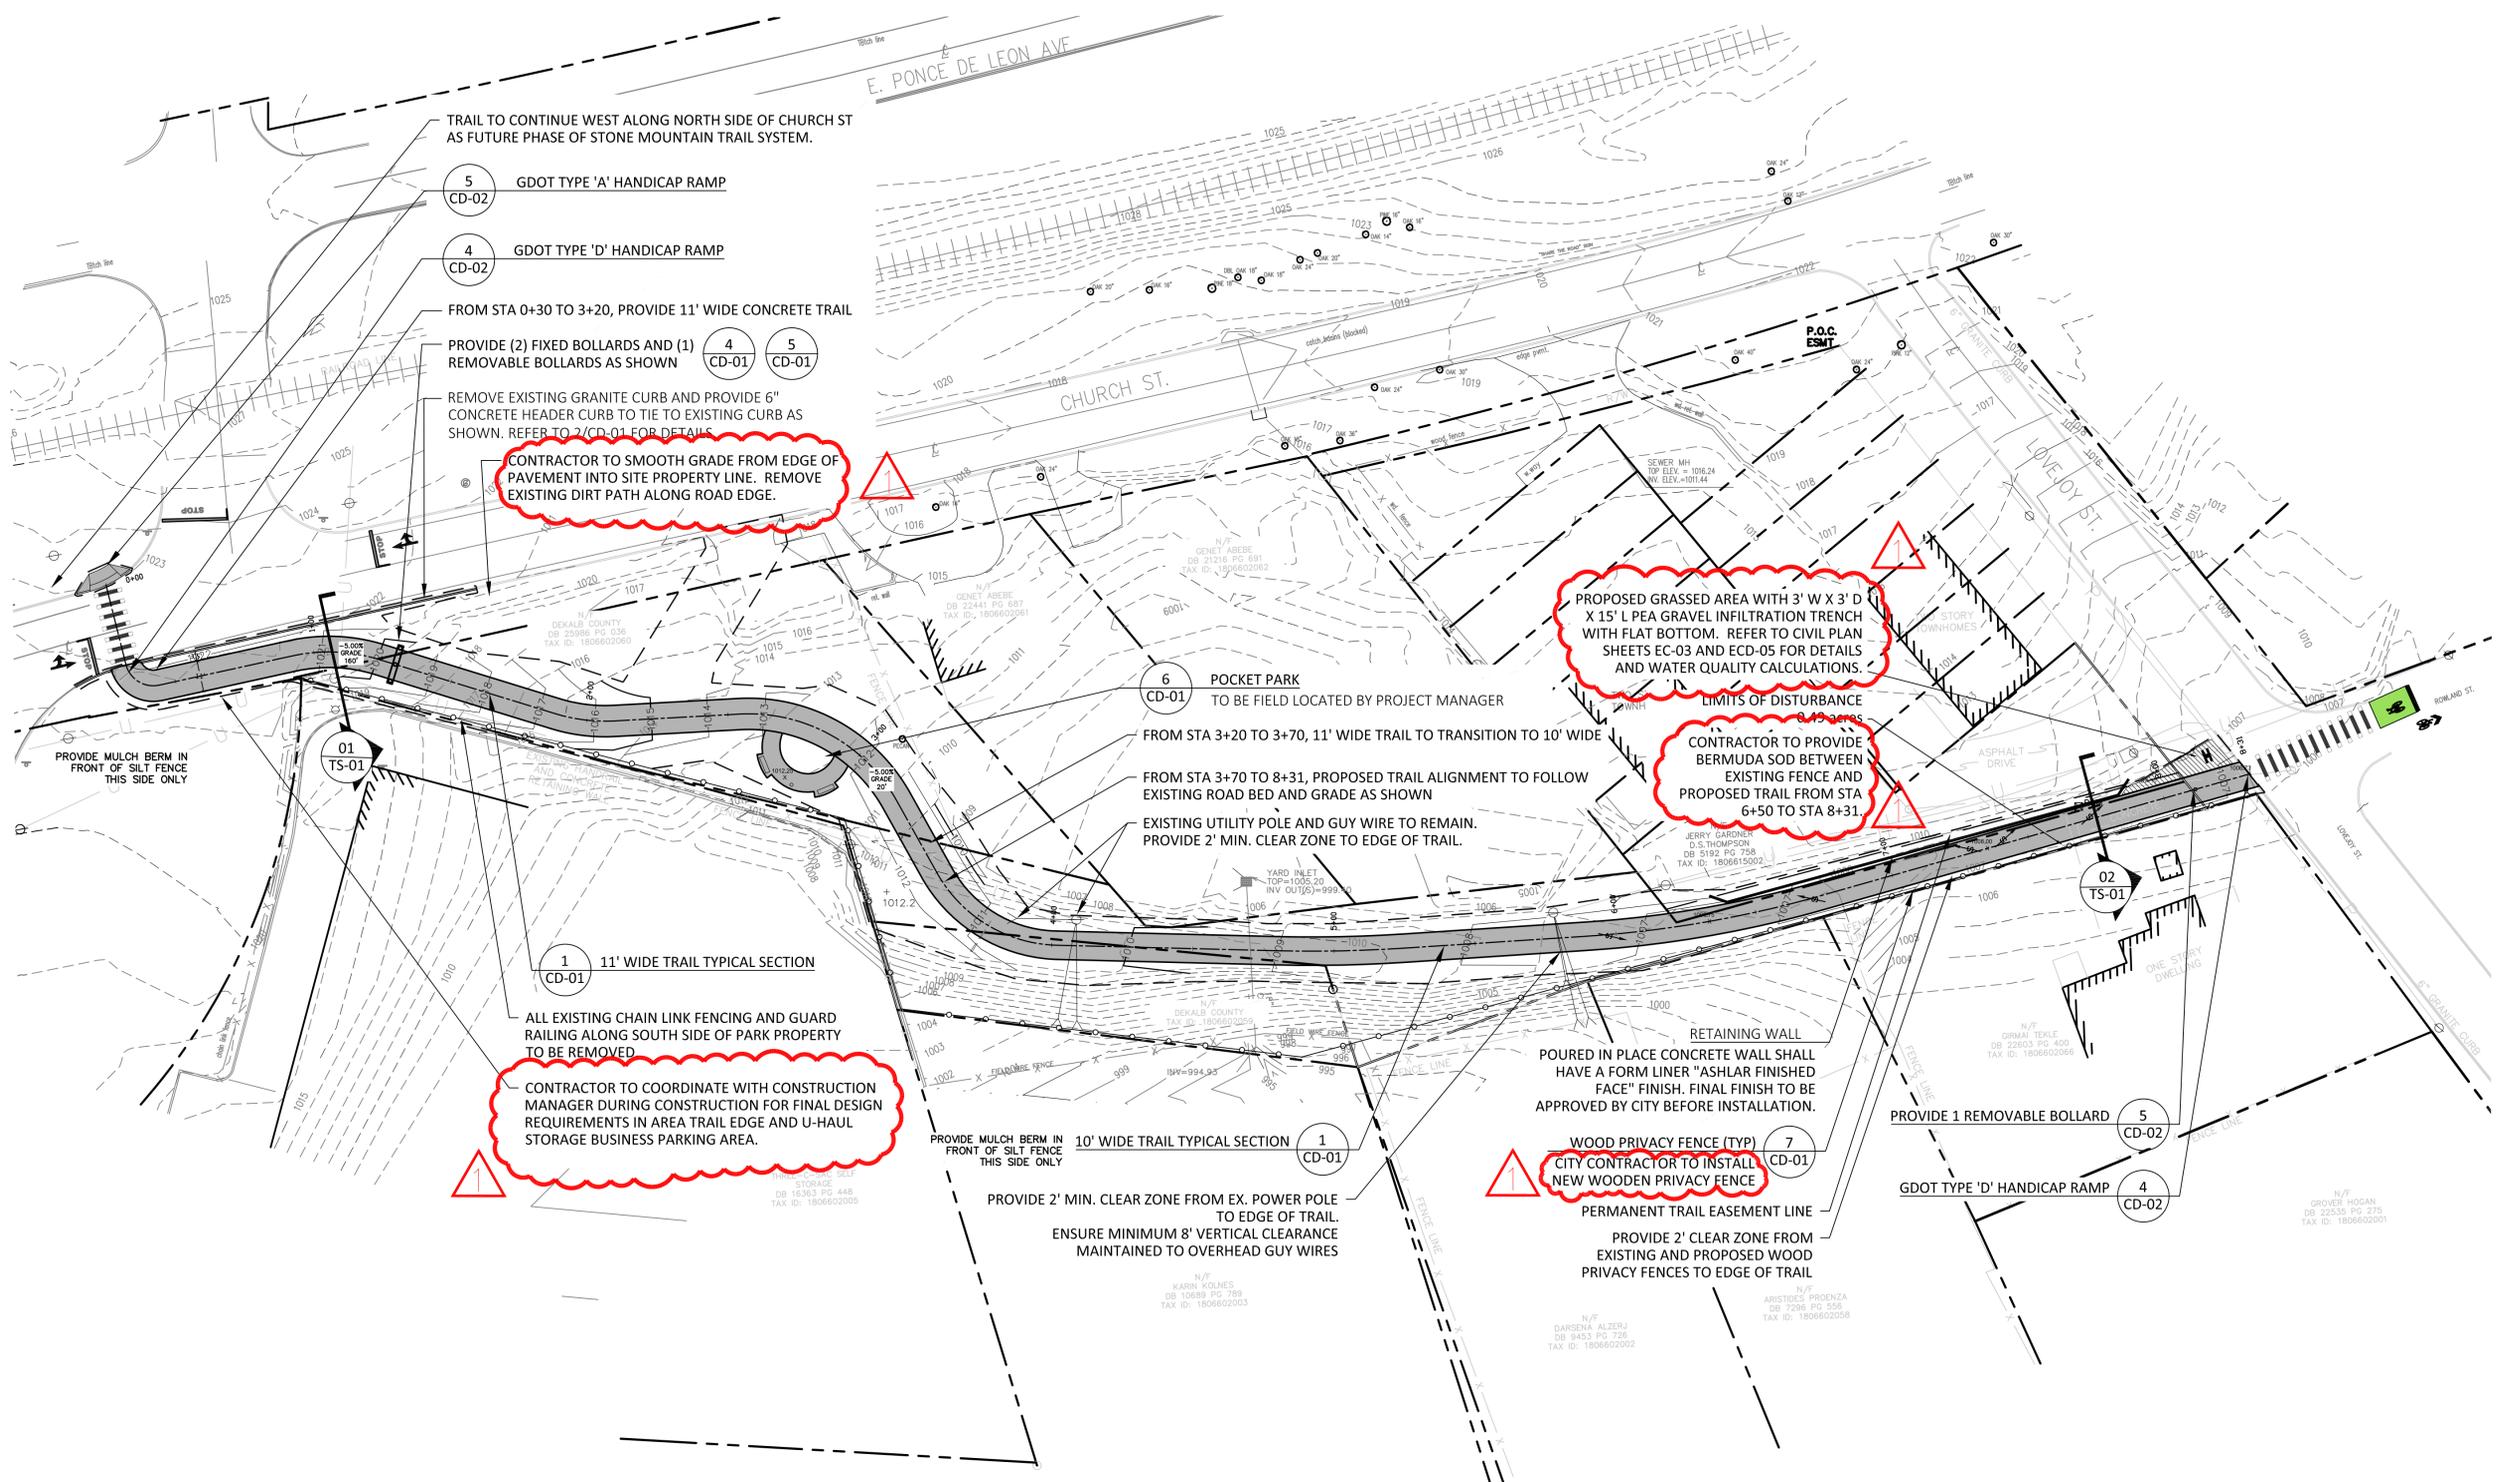

NOTES:

1. ALL DEMOLITION WASTE SHALL BE DISPOSED OF OFF SITE AT A STATE APPROVED LANDFILL.
2. CONTRACTOR TO REMOVE ALL EXISTING DEBRIS/TRASH IN AREA OF TRAIL CORRIDOR. CONSTRUCTION MANAGER TO APPROVE ALL FINAL REMOVAL AREAS.
3. REFER TO SIGNING AND MARKING PLAN FOR ALL PROPOSED TRAIL SIGNS AND PAVEMENT MARKINGS.
4. CONTRACTOR TO COORDINATE WITH LANDSCAPE ARCHITECT FOR STAKING DATA FILE PRIOR TO CONSTRUCTION.

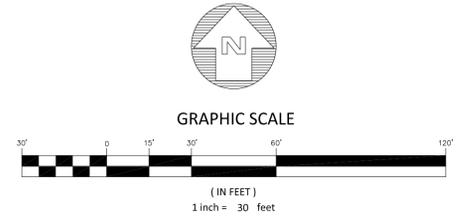

KAIZENCOLLABORATIVE
 2390 Main Street | Tucker, GA 30084 | 404.239.2521

RUSSELL DAVIS & ASSOCIATES, INC.
 CIVIL ENGINEERING DESIGN
 3469 Lawrenceville Highway, Suite 309
 Tucker, Georgia 30084
 (678) 935-7200
 russdavispe.com

REVISION	DATE	DESCRIPTION
1	2017-08-14	CITY COMMENTS

KAIZEN PROJECT # 2016 - 104
 PROJECT MANAGER: GGD





STONE MOUNTAIN PATH
CLARKSTON, GA



CONSTRUCTION PLAN

SCALE: 1"=30'
 DATE: AUG 1, 2017
 SHEET NAME: **CP-01**

STONE MOUNTAIN PATH - PHASE D - 1 OF 1

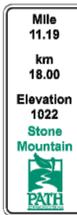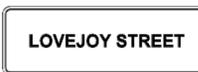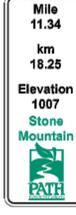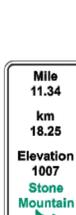   <p>Regulatory Sign #1 - Front STA 0+00</p>	   <p>Regulatory Sign #1 - Back STA 0+00</p>	   <p>Regulatory Sign #2 - Front STA 8+30</p>	   <p>Regulatory Sign #2 - Back STA 8+30</p>
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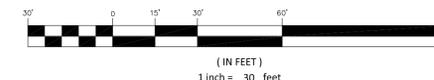
Blank Space Left Intentionally

NOTES:

1. ALL SIGNS TO BE FABRICATED USING DIRECT PRINTING PROCESS.
2. ALL SIGN PANELS TO HAVE A BLACK BACK.



GRAPHIC SCALE



KAIZENCOLLABORATIVE

2390 Main Street | Tucker, GA 30084 | 404.239.2521

REVISION	DATE	DESCRIPTION

KAIZEN PROJECT # 2016 - 104
PROJECT MANAGER: GGD


STONE MOUNTAIN PATH
CLARKSTON, GA



SIGNING AND MARKING SIGN MATRIX



SCALE: 1"=30'
DATE: AUG 1, 2017

SHEET NAME: **SM-02**

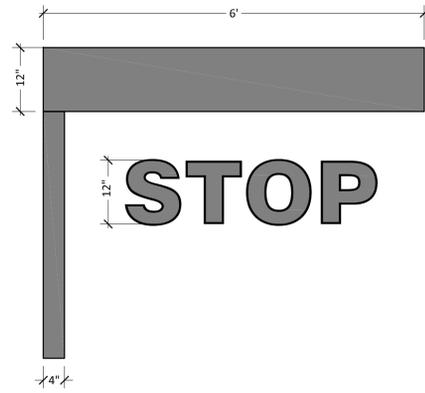

NOTES:
STOP BAR WORD AND STOP BAR SYMBOL SHALL MATCH TRAIL CENTERLINE PAINT COLOR.

NOTES:
1. ALL COLOR PAVEMENT MARKINGS TO BE ANTI SKID WITH CLEAN CUT EDGES (TYP.). CONFORM TO GDOT STANDARD SPECIFICATIONS FOR INSTALLATION, AND FINISH.
2. USE CASTEK COLOR SAFE, OR APPROVED EQUAL.
*USE 5' FOR (L / 2) WHEN LANE WIDTH EXCEEDS 12', OR WHERE LANE LINES HAVE BEEN OMITTED.

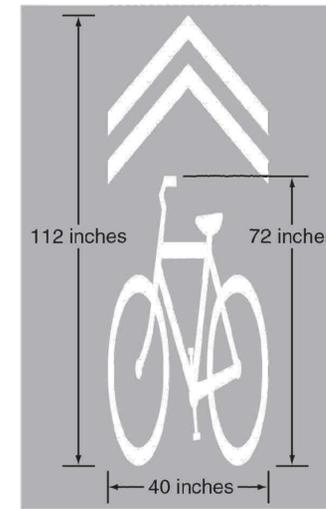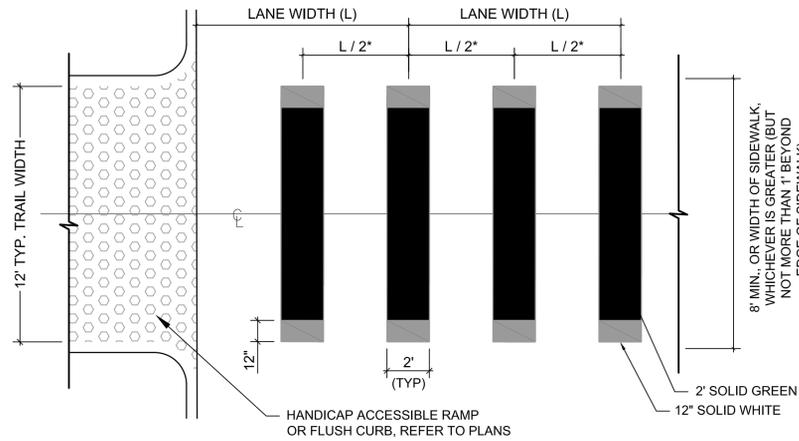

1 STOP BAR PAINT
CD-02 SCALE: 3/4" = 1'-0"


2 GREEN CROSSWALK STRIPING
CD-02 SCALE: 1/4" = 1'-0"

3 BIKE SHARED LANE SYMBOL
CD-02 N.T.S.


Type D

(Normally used when the sidewalk ties directly into the crosswalk)


DIFFERENCE IN HEIGHT	LENGTH REQUIRED
1 inch	1 foot
2 inches	2 feet
3 inches	3 feet
4 inches	4 feet
5 inches	5 feet
6 inches	6 feet

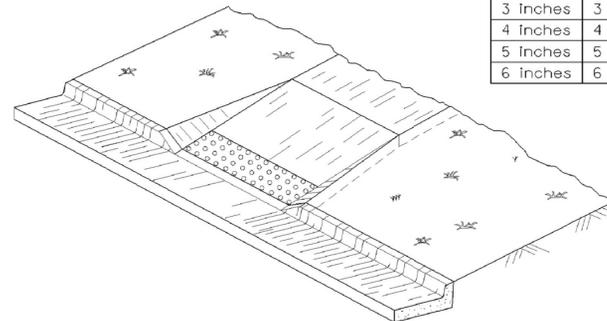

IN AREAS WHERE THE GUTTER HAS A SLOPE 1" IN 1' END NORMAL GUTTER SLOPE AT A DISTANCE OF 6 TO 10 FEET FROM THE RAMP AND BEGIN TRANSITION TO A FLAT GUTTER SLOPE. NORMAL GUTTER SLOPE SHALL BE RESUMED AT A SIMILAR DISTANCE BEYOND THE RAMP.

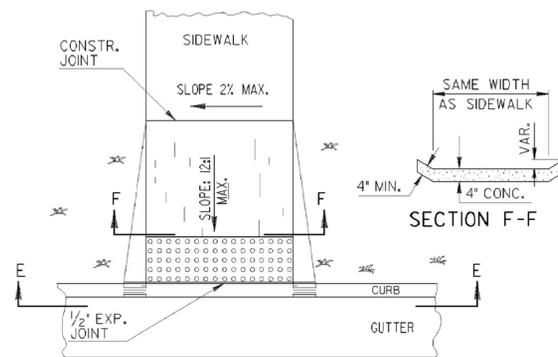

PLAN VIEW

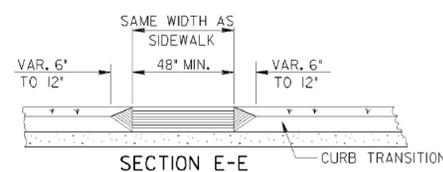

SECTION E-E


4 GDOT TYPE 'D' HANDICAP RAMP
CD-02 SCALE: 1/2" = 1'-0"

Type A

(The Preferred Ramp)


Back of sidewalk shall be located as shown in the plans or as directed by the Engineer so as not to encroach into the required landing area.

DIFFERENCE IN HEIGHT	LENGTH REQUIRED
1 inch	10 inches
2 inches	1'-8"
3 inches	2'-6"
4 inches	3'-4"
5 inches	4'-2"
6 inches	5 feet

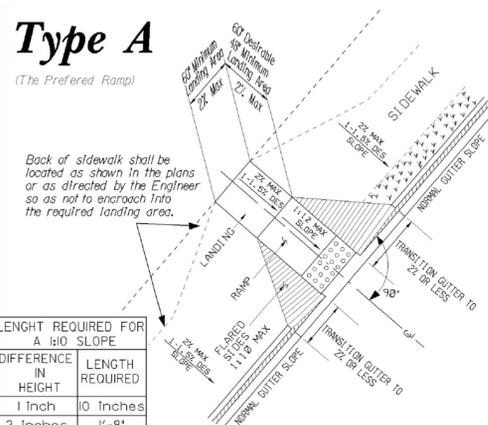


5 GDOT TYPE 'A' HANDICAP RAMP
CD-02 SCALE: 1/2" = 1'-0"

NOTES:
1. PATH FOUNDATION TO DETERMINE IN FIELD THE APPROPRIATE SIGN TO BE UTILIZED BASED ON FIELD CONDITIONS AND AVAILABLE SPACE FOR SIGNAGE.
2. ALL SIGNS SHALL BE LOCATED WITH 2'-0" CLEAR AREA FROM EDGE OF TRAILWAY TO EDGE OF SIGN.
3. ALL SIGNS TO BE ATTACHED TO SIGNPOST USING 1" LONG, 1/4 DIAMETER, STAINLESS STEEL #14A BUTTON HD TORX SECURITY WOOD SCREW.

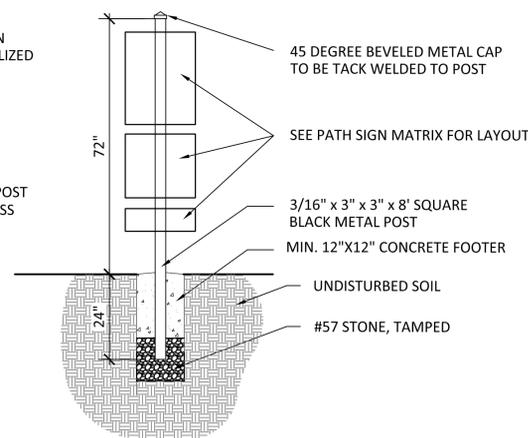

7 REGULATORY TRAIL SIGNS
CD-02 SCALE: 1/2" = 1'-0"

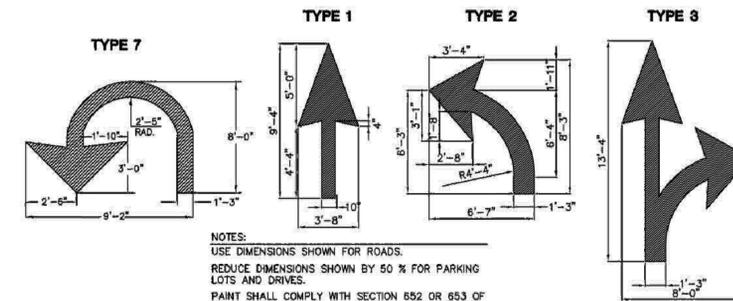

NOTES:
USE DIMENSIONS SHOWN FOR ROADS.
REDUCE DIMENSIONS SHOWN BY 50 % FOR PARKING LOTS AND DRIVES.
PAINT SHALL COMPLY WITH SECTION 652 OR 653 OF G.A.D.O.T. STANDARDS & SPECIFICATIONS OF ROADS AND BRIDGES.

PAVEMENT MARKINGS

N.T.S.

6 GDOT PAVEMENT MARKING DETAILS
CD-02 N.T.S.

BLANK SPACE LEFT INTENTIONALLY.

KAIZENCOLLABORATIVE

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REVISION	DATE	DESCRIPTION

KAIZEN PROJECT # 2016-104
PROJECT MANAGER GGD


STONE MOUNTAIN PATH
CLARKSTON, GA



CONSTRUCTION DETAILS

SCALE: VARIES
DATE: AUG 1, 2017

SHEET NAME: **CD-02**

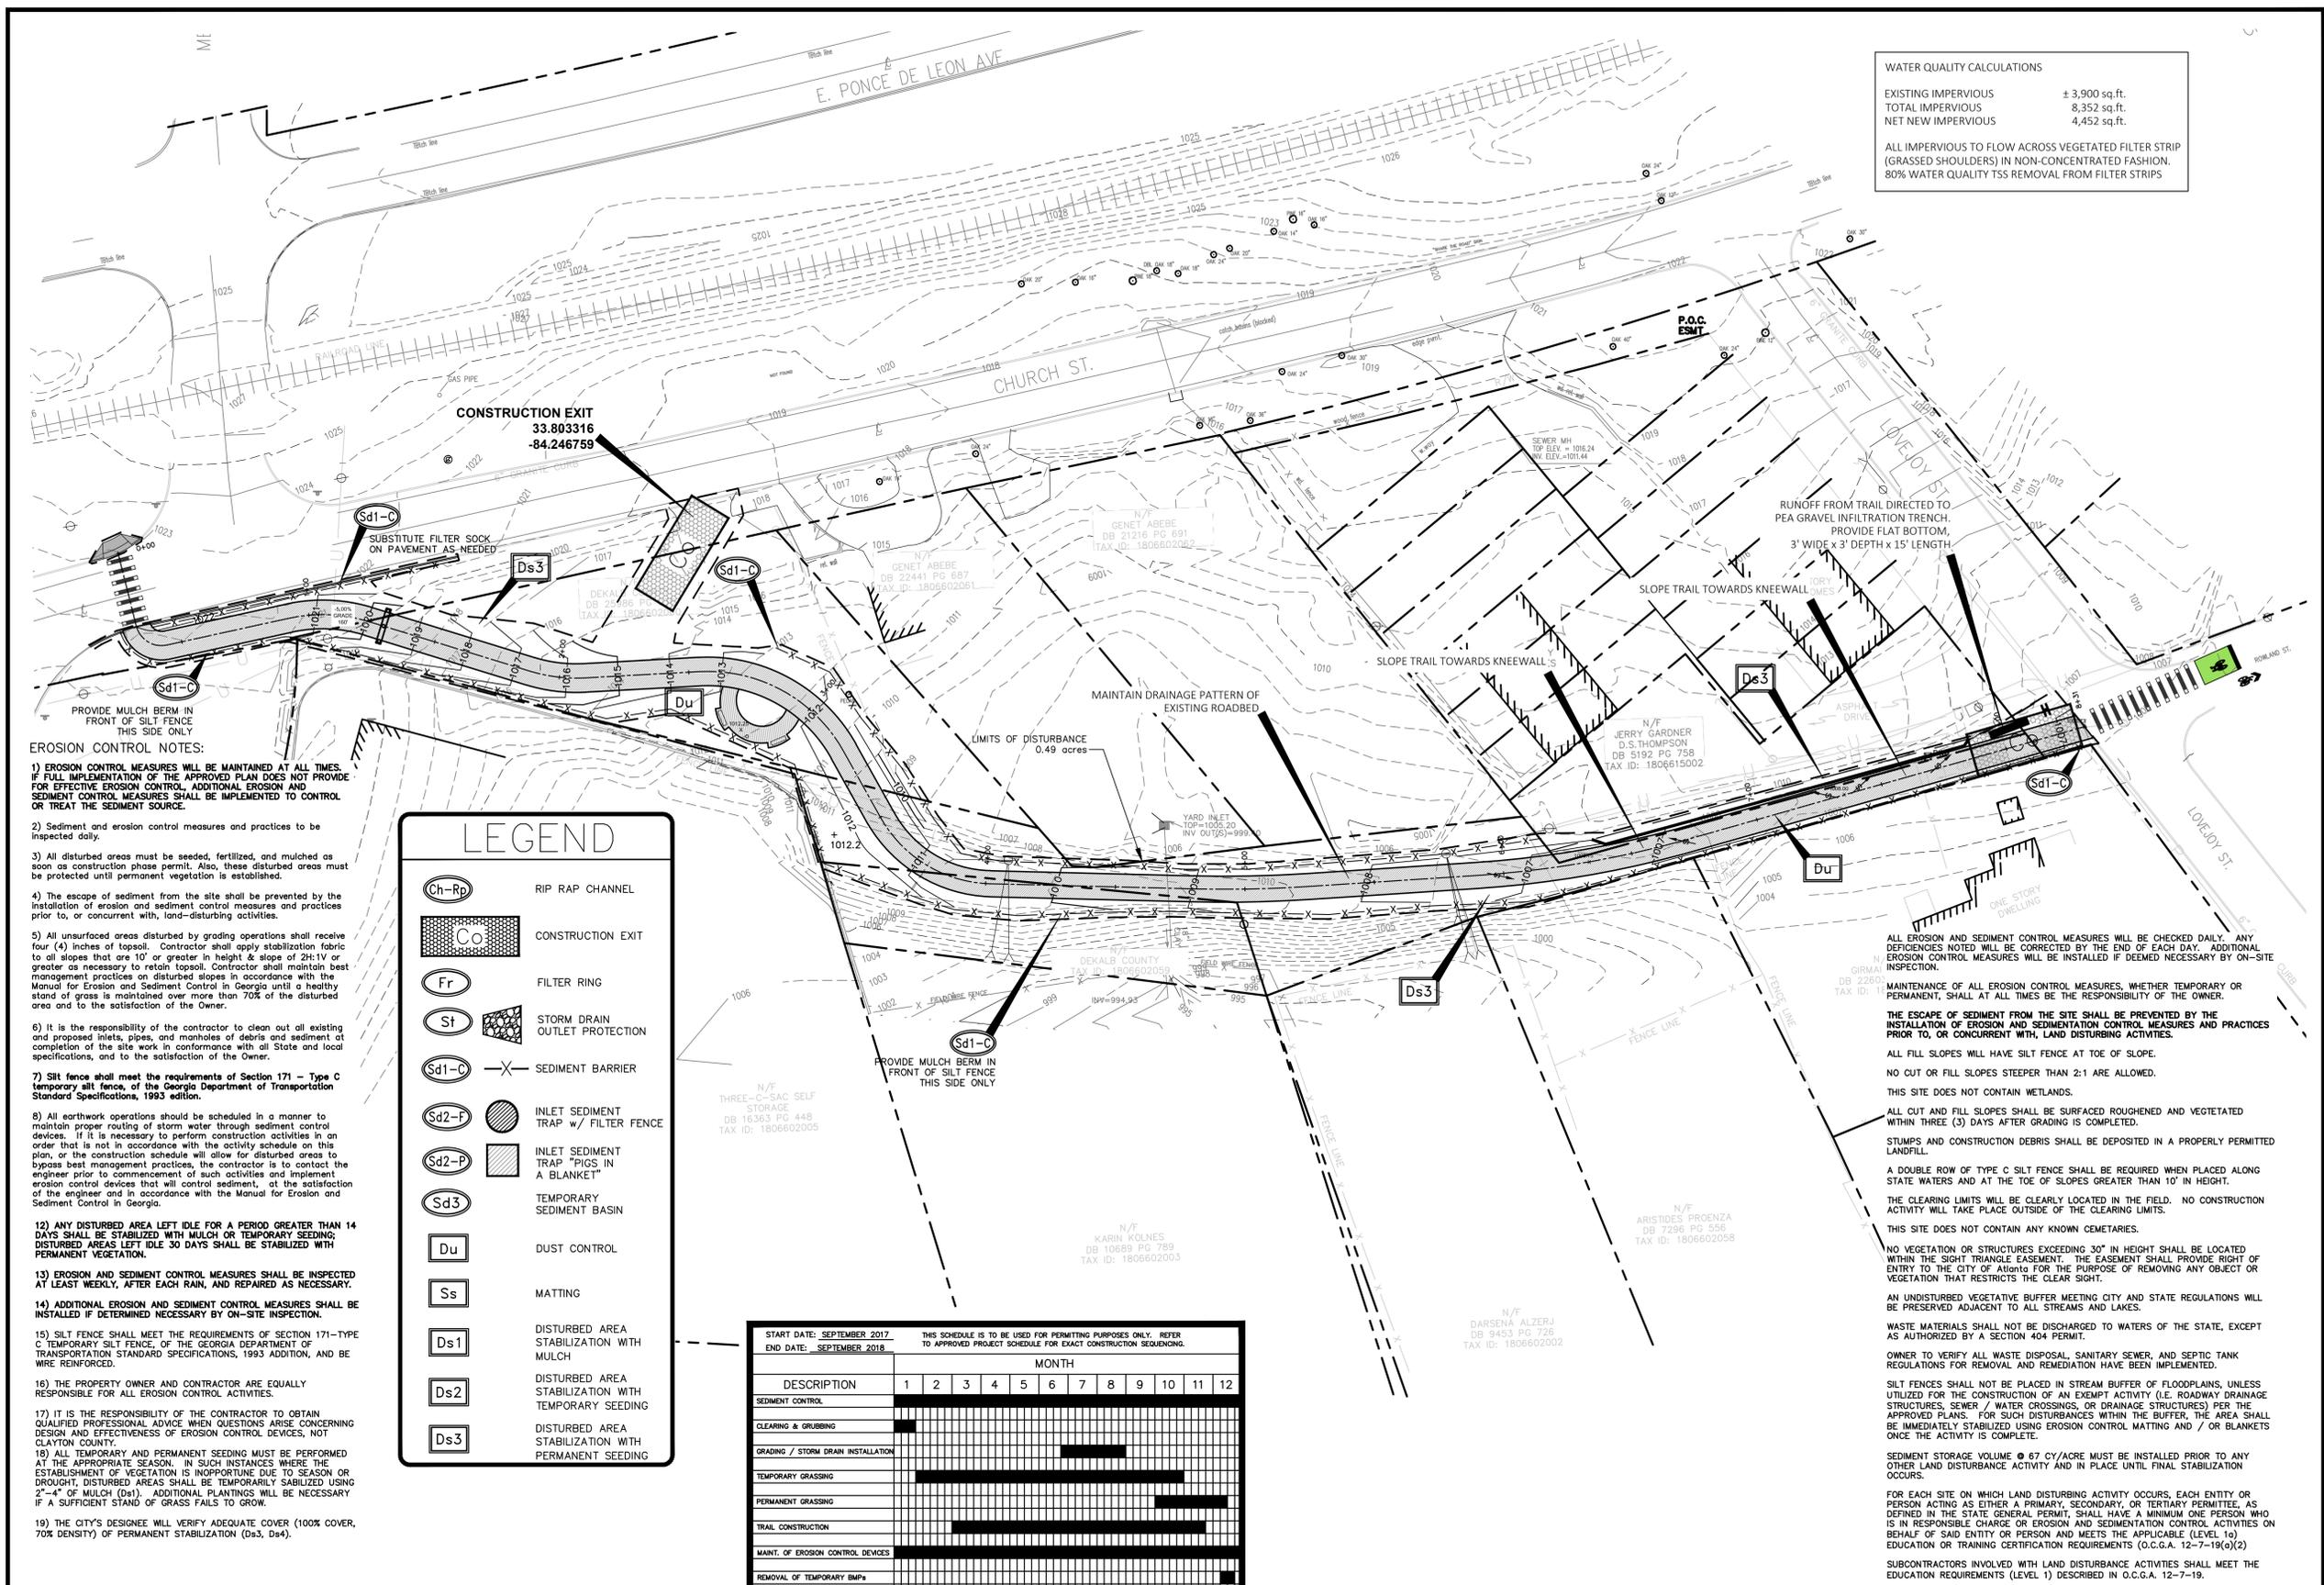

WATER QUALITY CALCULATIONS

EXISTING IMPERVIOUS ± 3,900 sq.ft.
 TOTAL IMPERVIOUS 8,352 sq.ft.
 NET NEW IMPERVIOUS 4,452 sq.ft.

ALL IMPERVIOUS TO FLOW ACROSS VEGETATED FILTER STRIP (GRASSED SHOULDERS) IN NON-CONCENTRATED FASHION. 80% WATER QUALITY TSS REMOVAL FROM FILTER STRIPS

- EROSION CONTROL NOTES:**
- 1) EROSION CONTROL MEASURES WILL BE MAINTAINED AT ALL TIMES. IF FULL IMPLEMENTATION OF THE APPROVED PLAN DOES NOT PROVIDE FOR EFFECTIVE EROSION CONTROL, ADDITIONAL EROSION AND SEDIMENT CONTROL MEASURES SHALL BE IMPLEMENTED TO CONTROL OR TREAT THE SEDIMENT SOURCE.
 - 2) Sediment and erosion control measures and practices to be inspected daily.
 - 3) All disturbed areas must be seeded, fertilized, and mulched as soon as construction phase permit. Also, these disturbed areas must be protected until permanent vegetation is established.
 - 4) The escape of sediment from the site shall be prevented by the installation of erosion and sediment control measures and practices prior to, or concurrent with, land-disturbing activities.
 - 5) All unsurfaced areas disturbed by grading operations shall receive four (4) inches of topsoil. Contractor shall apply stabilization fabric to all slopes that are 10' or greater in height & slope of 2H:1V or greater as necessary to retain topsoil. Contractor shall maintain best management practices on disturbed slopes in accordance with the Manual for Erosion and Sediment Control in Georgia until a healthy stand of grass is maintained over more than 70% of the disturbed area and to the satisfaction of the Owner.
 - 6) It is the responsibility of the contractor to clean out all existing and proposed inlets, pipes, and manholes of debris and sediment at completion of the site work in conformance with all State and local specifications, and to the satisfaction of the Owner.
 - 7) Silt fence shall meet the requirements of Section 171 - Type C temporary silt fence, of the Georgia Department of Transportation Standard Specifications, 1993 edition.
 - 8) All earthwork operations should be scheduled in a manner to maintain proper routing of storm water through sediment control devices. If it is necessary to perform construction activities in an order that is not in accordance with the activity schedule on this plan, or the construction schedule will allow for disturbed areas to bypass best management practices, the contractor is to contact the engineer prior to commencement of such activities and implement erosion control devices that will control sediment, at the satisfaction of the engineer and in accordance with the Manual for Erosion and Sediment Control in Georgia.
 - 12) ANY DISTURBED AREA LEFT IDLE FOR A PERIOD GREATER THAN 14 DAYS SHALL BE STABILIZED WITH MULCH OR TEMPORARY SEEDING; DISTURBED AREAS LEFT IDLE 30 DAYS SHALL BE STABILIZED WITH PERMANENT VEGETATION.
 - 13) EROSION AND SEDIMENT CONTROL MEASURES SHALL BE INSPECTED AT LEAST WEEKLY, AFTER EACH RAIN, AND REPAIRED AS NECESSARY.
 - 14) ADDITIONAL EROSION AND SEDIMENT CONTROL MEASURES SHALL BE INSTALLED IF DETERMINED NECESSARY BY ON-SITE INSPECTION.
 - 15) SILT FENCE SHALL MEET THE REQUIREMENTS OF SECTION 171-TYPE C TEMPORARY SILT FENCE, OF THE GEORGIA DEPARTMENT OF TRANSPORTATION STANDARD SPECIFICATIONS, 1993 ADDITION, AND BE WIRE REINFORCED.
 - 16) THE PROPERTY OWNER AND CONTRACTOR ARE EQUALLY RESPONSIBLE FOR ALL EROSION CONTROL ACTIVITIES.
 - 17) IT IS THE RESPONSIBILITY OF THE CONTRACTOR TO OBTAIN QUALIFIED PROFESSIONAL ADVICE WHEN QUESTIONS ARE CONCERNING DESIGN AND EFFECTIVENESS OF EROSION CONTROL DEVICES, NOT CLAYTON COUNTY.
 - 18) ALL TEMPORARY AND PERMANENT SEEDING MUST BE PERFORMED AT THE APPROPRIATE SEASON. IN SUCH INSTANCES WHERE THE ESTABLISHMENT OF VEGETATION IS INOPPORTUNE DUE TO SEASON OR DROUGHT, DISTURBED AREAS SHALL BE TEMPORARILY STABILIZED USING 2"-4" OF MULCH (Ds1). ADDITIONAL PLANTINGS WILL BE NECESSARY IF A SUFFICIENT STAND OF GRASS FAILS TO GROW.
 - 19) THE CITY'S DESIGNEE WILL VERIFY ADEQUATE COVER (100% COVER, 70% DENSITY) OF PERMANENT STABILIZATION (Ds3, Ds4).

LEGEND

- (Ch-Rp) RIP RAP CHANNEL
- (Co) CONSTRUCTION EXIT
- (Fr) FILTER RING
- (St) STORM DRAIN OUTLET PROTECTION
- (Sd1-C) SEDIMENT BARRIER
- (Sd2-F) INLET SEDIMENT TRAP w/ FILTER FENCE
- (Sd2-P) INLET SEDIMENT TRAP "PIGS IN A BLANKET"
- (Sd3) TEMPORARY SEDIMENT BASIN
- (Du) DUST CONTROL
- (Ss) MATTING
- (Ds1) DISTURBED AREA STABILIZATION WITH MULCH
- (Ds2) DISTURBED AREA STABILIZATION WITH TEMPORARY SEEDING
- (Ds3) DISTURBED AREA STABILIZATION WITH PERMANENT SEEDING

START DATE: SEPTEMBER 2017 THIS SCHEDULE IS TO BE USED FOR PERMITTING PURPOSES ONLY. REFER TO APPROVED PROJECT SCHEDULE FOR EXACT CONSTRUCTION SEQUENCING.

END DATE: SEPTEMBER 2018

DESCRIPTION	MONTH											
	1	2	3	4	5	6	7	8	9	10	11	12
SEDIMENT CONTROL												
CLEARING & GRUBBING												
GRADING / STORM DRAIN INSTALLATION												
TEMPORARY GRASSING												
PERMANENT GRASSING												
TRAIL CONSTRUCTION												
MAINT. OF EROSION CONTROL DEVICES												
REMOVAL OF TEMPORARY BMPs												
CLEARING OF STORM DRAINS												
FINAL CLEAN UP												


ACTIVITY SCHEDULE

NON-EXEMPT ACTIVITIES SHALL NOT BE CONDUCTED WITHIN THE 25 OR 50-FOOT UNDISTURBED STREAM BUFFERS AS MEASURED FROM THE POINT OF WRESTED VEGETATION WITHOUT FIRST ACQUIRING THE NECESSARY VARIANCES AND PERMITS.

AMENDMENTS/REVISIONS TO ES&PC PLAN WHICH HAVE A SIGNIFICANT EFFECT ON BMP'S WITH A HYDRAULIC COMPONENT MUST BE CERTIFIED BY THE DESIGN PROFESSIONAL.

NON-EXEMPT ACTIVITIES SHALL NOT BE CONDUCTED WITHIN THE 25 OR 50 FOOT UNDISTURBED BUFFERS AS MEASURED FROM THE POINT OF WRESTED VEGETATION WITHOUT FIRST ACQUIRING THE NECESSARY VARIANCES AND PERMITS.

ALL EROSION AND SEDIMENTATION CONTROLS, AND TREE PROTECTION MEASURES SHALL BE INSTALLED PRIOR TO GRADING.

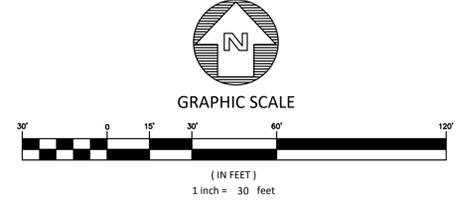

811 UTILITIES PROTECTION CENTER, INC.
 Call 811 or toll-free 800-282-7411 throughout Georgia.
 Outside Georgia call 770-623-4344 prior to all construction activities.
 THE LOCATION OF UTILITIES ARE SHOWN FROM FIELD EVIDENCE.
 OTHER UTILITIES MAY BE PRESENT THAT ARE NOT SHOWN.
 BEFORE CONSTRUCTION IT IS RECOMMENDED THAT A PRIVATE UTILITY LOCATOR INVESTIGATE ALL UNDERGROUND UTILITIES.

GSWCC
 Georgia Storm Water Construction Consortium
 Russell Davis #24598
 Expires 12/01/2018


24 hr EMERGENCY CONTACT
JONATHAN MCCAIG ~ PATH FOUNDATION
 LEVEL 1 CERT #58893 ~ EXP 10/11/2018
 office 404-875-7284 x5 cell 404-433-1900

I CERTIFY UNDER PENALTY OF LAW THAT THIS PLAN WAS PREPARED AFTER A SITE VISIT TO THE LOCATION DESCRIBED HEREIN BY MYSELF OR MY AUTHORIZED AGENT UNDER MY DIRECT SUPERVISION.

RUSSELL E. DAVIS, P.E.
 GSWCC # 0000024598
 EXPIRES: 11/29/2018

KAIZENCOLLABORATIVE
 2390 Main Street | Tucker, GA 30084 | 404.239.2521

RUSSELL DAVIS & ASSOCIATES, INC.
 CIVIL ENGINEERING DESIGN
 3469 Lawrenceville Highway, Suite 309
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 (678) 935-2200
 russdavispe.com

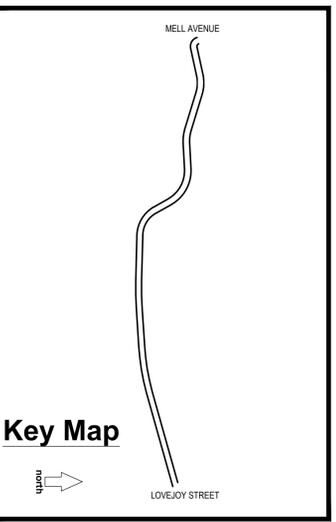

REVISION	DATE	DESCRIPTION
1	08-18-17	CITY COMMENTS

KAIZEN PROJECT # 2016 - 104
 PROJECT MANAGER GGD

**STONE MOUNTAIN PATH
 CLARKSTON, GA**

GEORGIA REGISTERED PROFESSIONAL ENGINEER
 RUSSELL E. DAVIS
 No. 3662
 07/24/2017

FINAL PHASE EROSION, SEDIMENTATION & POLLUTION CONTROL PLAN

SCALE: 1"=30'
 DATE: AUG 1, 2017
 SHEET NAME: **EC-03**

REQUIREMENT FOR REGULATORY COMPLIANCE

Mulch or temporary grassing shall be applied to all exposed areas within 14 days of disturbance. Mulch can be used as a singular erosion control device for up to six months, but it shall be applied at the appropriate depth, depending on the material used, anchored, and have a continuous 90% cover or greater of the soil surface. Maintenance shall be required to maintain appropriate depth and 90% cover. Temporary vegetation may be employed instead of mulch if the area will remain undisturbed for less than six months. If an area will remain undisturbed for greater than six months, permanent vegetative techniques shall be employed. Refer to Ds2-Disturbed Area Stabilization (With Temporary Seeding), Ds3-Disturbed Area Stabilization (With Permanent Seeding), and Ds4-Disturbed Area Stabilization (With Sodding).

SPECIFICATIONS

Mulching without Seeding
This standard applies to grades or cleared areas where seedings may not have a suitable growing season to produce an erosion retardant cover, but can be stabilized with a mulch cover.

- Site Preparation**
- Grade to permit the use of equipment for applying and anchoring mulch.
 - Install needed erosion control measures as required such as dikes, diversions, berms, terraces and sediment barriers.
 - Loosen compact soil to a minimum depth of 3 inches.

Mulching Materials
Select one of the following materials and apply at the depth indicated:
1. Dry straw or hay shall be applied at a depth of 2 to 4 inches providing complete soil coverage. One advantage of this material is easy application.
2. Wood waste (chips, sawdust or bark) shall be applied at a depth of 2 to 3 inches. Organic material from the clearing stage of development should remain on site, be chipped, and applied as mulch. This method of mulching can greatly reduce erosion control costs.
3. Polyethylene film shall be secured over banks or stockpiled soil material for temporary protection. This material can be salvaged and re-used.

Applying Mulch
When mulch is used without seeding, mulch shall be applied to provide full coverage of the exposed area.
1. Dry straw or hay mulch and wood chips shall be applied uniformly by hand or by mechanical equipment.
2. If the area will eventually be covered with perennial vegetation, 20-30 pounds of nitrogen per acre in addition to the normal amount shall be applied to offset the uptake of nitrogen caused by the decomposition of the organic mulches.
3. Apply polyethylene film on exposed areas.

Anchoring Mulch
1. Straw or hay mulch can be pressed into the soil with a disk arrow with the disk set straight or with a special "pucker disk." Disks may be smooth or serrated and should be 20 inches or more in diameter and 8 to 12 inches apart. The edges of the disk should be dull enough to cut the mulch but to press it into the soil leaving much of it in an erect position. **STRAW OR HAY MULCH SHALL BE ANCHORED IMMEDIATELY AFTER APPLICATION.** Straw or hay mulch spread with special blower-type equipment may be anchored. Tackifiers, binders and hydraulic mulch with tackifier specifically designed for tacking straw can be substituted for emulsified asphalt. Please refer to specification Tack-Tackifiers. Plastic mesh or netting with mesh no larger than one inch by one inch shall be installed according to manufacturer's specifications.

- Netting of the appropriate size shall be used to anchor wood waste. Openings of the netting shall not be larger than the average size of the wood waste chips.
- Polyethylene film shall be anchor trenched at the top as well as incrementally as necessary.

DISTURBED AREA STABILIZATION (WITH MULCHING ONLY)

(NTS)

Ds1

REQUIREMENT FOR REGULATORY COMPLIANCE

Refer to specification Ds1 - Disturbed Area Stabilization (With Temporary Seeding).

INSTALLATION SPECIFICATIONS

Grading and shaping
Excessive water run-off shall be reduced by properly designed and installed erosion control practices such as closed drains, ditches, dikes, diversions, sediment barriers and others. No shaping or grading is required if slopes can be stabilized by hand-seeded vegetation or if hydraulic seeding equipment is to be used.

Seeded preparation
When a hydraulic seeder is used, seedbed preparation is not required. When using conventional or hand-seeding, seedbed preparation is not required if the soil material is loose and not seeded by rainfall. When soil has been sealed by rainfall or consists of smooth cut slopes, the soil shall be pitted, trenched or otherwise scarified to provide a place for seed to lodge and germinate.

Lime and fertilizer
Agricultural lime is required unless soil tests indicate otherwise. Apply agricultural lime at a rate determined by soil test for pH. Quick acting lime should be incorporated to modify pH during the germination period. Bio stimulants should also be considered when there is less than 3% organic matter in the soil. Graded areas require lime application. Soils must be tested to determine required amounts of fertilizer and amendments. Fertilizer should be applied before land preparation and incorporated with a disk, ripper or chisel. On slopes too steep for, or inaccessible to equipment, fertilizer shall be hydraulically applied, preferably in the first pass with seed, and shume hydraulic mulch, then topped with the remaining required application rate.

Apply agricultural lime at a rate of one ton per acre. Graded areas require lime application. Soils can be tested to determine if fertilizer is needed. On reasonably fertile soils or soil material, fertilizer is not required. For soils with very low fertility, 500 to 700 pounds of 10-10-10 fertilizer or the equivalent per acre (12-16 lbs./1,000 sq. ft.) shall be applied. Fertilizer should be applied before land preparation and incorporated with a disk, ripper or chisel.

Seeding
Select a grass or grass-legume mixture suitable to the area and season of the year. Seed shall be applied uniformly by hand, cyclone seeder, drill, cultipacker-seeder, or hydraulic seeder (slurry including seed and fertilizer). Drill or cultipacker seeders should normally place seed one-quarter to one-half inch deep. Appropriate depth of planting is ten times the seed diameter. Soil should be "raked" lightly to cover seed with soil if seeded by hand. See Table 6-4.1.

Mulching
Temporary vegetation can, in most cases, be established without the use of mulch, provided there is little to no erosion potential. However, the use of mulch can often accelerate and enhance germination and vegetation establishment. Mulch without seeding should be considered for short term protection. Refer to Ds1-Disturbed Area Stabilization (With Mulching Only).

Irrigation
During times of drought, water shall be applied at a rate not causing runoff and erosion. The soil shall be thoroughly wetted to a depth that will insure germination of the seed. Subsequent applications should be made when needed.

SUGGESTED SEEDBED DEPTHS

SLOPE	SEEDBED DEPTHS
3:1 OR FLATTER	LESS THAN 4" DEPTH
2:1 TO 3:1	1" TO 4" DEPTH
DEPRESSIONS EVERY 6'-8' HAND DUG, IF NECESSARY	
2:1 OR STEEPER	6"-8" HAND DUG, IF NECESSARY

DISTURBED AREA STABILIZATION (WITH TEMPORARY SEEDING)

(NTS)


Ds2

PLANTS, PLANTING RATES AND PLANTING DATES FOR TEMPORARY COVER OF COMPANION CROPS 1/

Species	Broadcast Rates 2/3 - PLS 3/4 Per Acre	Resource Area 4/5 Per 1000 sq. ft.	Planting Dates by Resource Area												Remarks		
			J	F	M	A	M	J	J	A	S	O	N	D			
BARLEY (Hordeum vulgare)	3 bu. (144 lbs.)	3.3 bu. (144 lbs.)															14,000 seed per pound. Winterhardy. Use on productive soils.
LESPEDeza ANNUAL (Lepesedeza striata)	40 lbs.	0.9 bu. (40 lbs.)															200,000 seed per pound. May volunteer for several years. Use in low fertility soils.
LOVEGRASS, WEeping (Eragrostis curvata)	4 lbs.	0.1 bu. (4 lbs.)															1,500,000 seed per pound. Will provide too much competition in mixtures if seeded at high rates.
MILET, BROWNTOP (Panicum fasciculatum)	40 lbs.	0.9 bu. (40 lbs.)															137,000 seed per pound. Quick dense cover. May provide too much competition in mixtures if seeded at high rates.
MILET, PEARL (Pennisetum glaucum)	50 lbs.	1.1 bu. (50 lbs.)															85,000 seed per pound. Quick dense cover. Use on productive soils. Not as winterhardy as type or barley.
OATS (Avena sativa)	4 bu. (128 lbs.)	2.9 bu. (128 lbs.)															13,000 seed per pound. Use on productive soils. Not as winterhardy as type or barley.
RYE (Secale cereale)	3 bu. (144 lbs.)	3.9 bu. (144 lbs.)															18,000 seed per pound. Quick cover. Drought tolerant and winterhardy.
RYEGRASS, ANNUAL (Lolium temulentum)	40 lbs.	0.9 bu. (40 lbs.)															227,000 seed per pound. Dense cover. Very competitive and is NOT to be used in mixtures.
SUDANGRASS (Sorghum sudanense)	60 lbs.	1.4 bu. (60 lbs.)															50,000 seed per pound. Good on droughty soils. NOT recommended for mixtures.
TRITICALE (Triticosecalle)	3 bu. (144 lbs.)	3.3 bu. (144 lbs.)															Use on lower part of Southern Coastal Plain and in Atlantic Coastal Piedmont only.
WHEAT (Triticum aestivum)	3 bu. (144 lbs.)	4.1 bu. (144 lbs.)															18,000 seed per pound. Quick cover. Drought tolerant and winterhardy.

1/ Temporary cover strips are very competitive and will crowd out perennials if seeded too heavily.
2/ Reduce seeding rates by 50% when drilled.
3/ PLS is an abbreviation for Plant Law Seed.
4/ M-L represents the Mountain, Blue Ridge, and Ridges and Valleys MURAs.
5/ P represents the Southern Piedmont MURAs.
C represents Southern Coastal Plain, Sand Hills, Back Lands and Atlantic Coastal Piedmont MURAs.

CRUSHED STONE CONSTRUCTION EXIT

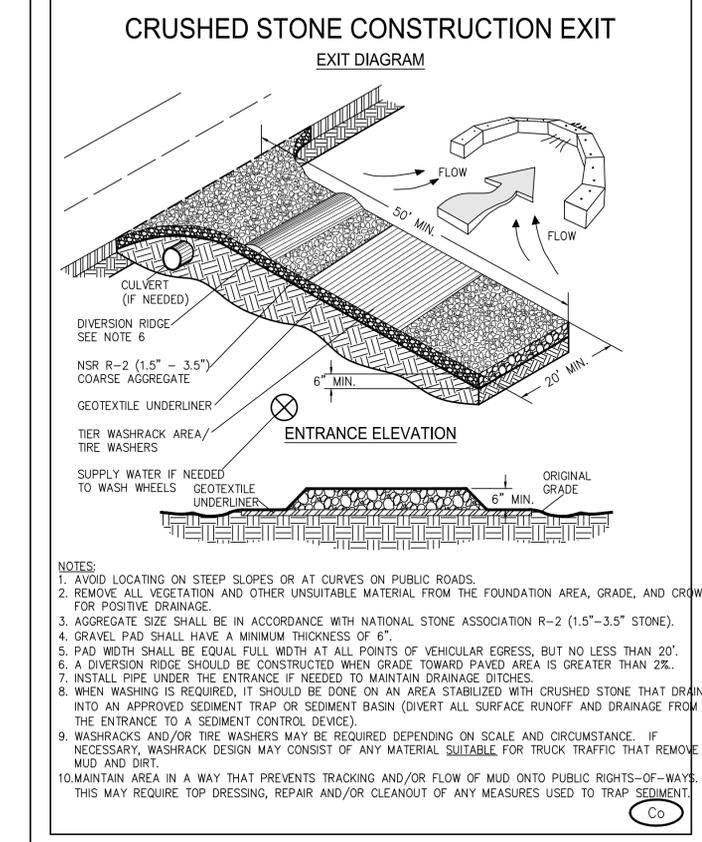

- NOTES:**
- AVOID LOCATING ON STEEP SLOPES OR AT CURVES ON PUBLIC ROADS.
 - REMOVE ALL VEGETATION AND OTHER UNSUITABLE MATERIAL FROM THE FOUNDATION AREA, GRADE, AND CROWN FOR POSITIVE DRAINAGE.
 - AGGREGATE SIZE SHALL BE IN ACCORDANCE WITH NATIONAL STONE ASSOCIATION R-2 (1.5"-3.5" STONE).
 - GRAVEL PAD SHALL HAVE A MINIMUM THICKNESS OF 6".
 - PAD WIDTH SHALL BE EQUAL FULL WIDTH AT ALL POINTS OF VEHICULAR EGRESS, BUT NO LESS THAN 20'.
 - A DIVERSION RIDGE SHOULD BE CONSTRUCTED WHEN GRADE TOWARD PAVED AREA IS GREATER THAN 2%.
 - INSTALL PIPE UNDER THE ENTRANCE IF NEEDED TO MAINTAIN DRAINAGE DITCHES.
 - WHEN WASHING IS REQUIRED, IT SHOULD BE DONE ON AN AREA STABILIZED WITH CRUSHED STONE THAT DRAINS INTO AN APPROVED SEDIMENT TRAP OR SEDIMENT BASIN (DIVERT ALL SURFACE RUNOFF AND DRAINAGE FROM THE ENTRANCE TO A SEDIMENT CONTROL DEVICE).
 - WASHRACKS AND/OR TIRE WASHERS MAY BE REQUIRED DEPENDING ON SCALE AND CIRCUMSTANCE. IF NECESSARY, WASHRACK DESIGN MAY CONSIST OF ANY MATERIAL SUITABLE FOR TRUCK TRAFFIC THAT REMOVE MUD AND DIRT.
 - MAINTAIN AREA IN A WAY THAT PREVENTS TRACKING AND/OR FLOW OF MUD ONTO PUBLIC RIGHTS-OF-WAYS. THIS MAY REQUIRE TOP DRESSING, REPAIR AND/OR CLEANOUT OF ANY MEASURES USED TO TRAP SEDIMENT.

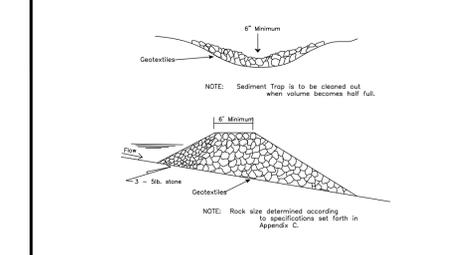


Figure 6-18.1

CONSTRUCTION SPECIFICATIONS:
Mechanical or hand placement will be required to insure that the rock dam extends completely across the channel and securely into both original banks. The center of the dam must be no less than six inches lower than the least side, to serve as a type 'V' gutter. Gabions can be installed to serve as rock filter dams, but should follow recommended sizing and installation specifications. Refer to specification Ds - Gabion.

**TABLE C-1
GRADED RIP-RAP STONES**

N.S.A. No.	SIZE INCHES (SQ. OPENING)		NO. PER SQ. YD.	STONE SIZE	FILTER
	MAX.	Avg.			
2.5	R-1	1 1/2	3/4	No. 8	FS-1
4.5	R-2	3	1 1/2	1	FS-1
6.5	R-3	6	3	2	FS-2
9.0	R-4	12	6	3	FS-2
11.5	R-5	18	9	5	FS-2
13.0	R-6	24	12	7	FS-3
14.5	R-7	30	15	12	FS-3

- TABLE C-2
FILTER BEDDING STONE**
- | N.S.A. No. | SIZE INCHES (SQ. OPENING) | | NO. PER SQ. YD. | STONE SIZE | FILTER |
|------------|---------------------------|----------|-----------------|------------|--------|
| | MAX. | Avg. | | | |
| FS-1 | 3/8" | Ø30 MESH | Ø100 | | |
| FS-2 | 2" | Ø4 MESH | Ø100 | | |
| FS-3 | 6 1/2" | 2 1/2" Ø | Ø16 | | |


- national stone association
- at least 50% of the individual stone particles must be equal or larger than this listed size.
- 85-100% of the individual stone particles must be less than listed size.

ROCK FILTER DAM

(NTS)

Rd

SOD MAINTENANCE AND INSTALLATION

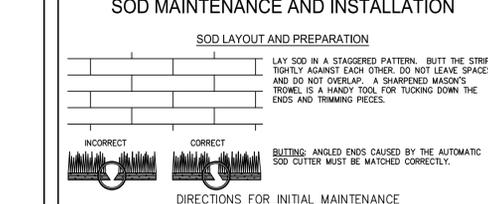

- DIRECTIONS FOR INITIAL MAINTENANCE**
- ROLL SOD IMMEDIATELY TO ACHIEVE FIRM CONTACT WITH THE SOIL.
 - WATER TO A DEPTH OF 4" AS NEEDED. WATER WELL AS SOON AS THE SOD IS LAID.
 - MOW WHEN THE SOD IS ESTABLISHED --- IN 2-3 WEEKS. SET THE MOWER HIGH (2"-3").

APPEARANCE OF GOOD SOD

SHOOTS OR GRASS BLADES: GRASS SHOULD BE GREEN AND HEALTHY, MOWED AT A 2"-3" CUTTING HEIGHT.

THATCH: GRASS CLIPPINGS AND DEAD LEAVES (UP TO 1/2" THICK).


ROOT ZONE: SOIL AND ROOTS. SHOULD BE 1/2"-3/4" THICK WITH DENSE ROOT MAT FOR STRENGTH.

DISTURBED AREA STABILIZATION (WITH SOD)

(NTS)

Sd1-Ns

SILT FENCE - TYPE SENSITIVE

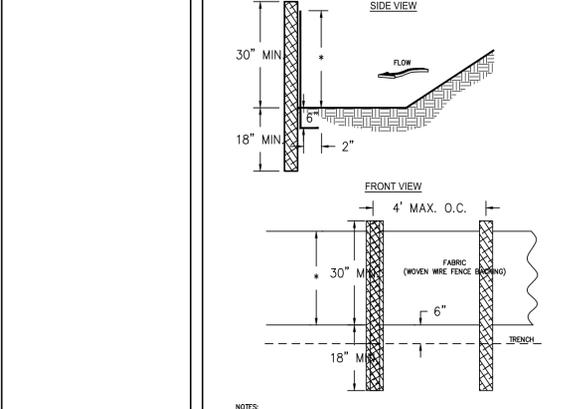

- NOTES:**
- USE STEEL OR WOOD POSTS OR AS SPECIFIED BY THE EROSION, SEDIMENTATION, AND POLLUTION CONTROL PLAN.
 - HEIGHT (H) IS TO BE SHOWN ON THE EROSION, SEDIMENTATION, AND POLLUTION CONTROL PLAN.


MAINTENANCE
Sediment shall be removed once it has accumulated to one-half the original height of the barrier. Filter fabric shall be replaced whenever it has deteriorated to such an extent that the effectiveness of the fabric is reduced (approximately six months). Temporary sediment barriers shall remain in place until disturbed areas have been permanently stabilized. All sediment accumulated at the barrier shall be removed and properly disposed of before the barrier is removed.

DISTURBED AREA STABILIZATION (WITH SILT FENCE)

(NTS)

Sd1-S

SILT FENCE - TYPE SENSITIVE

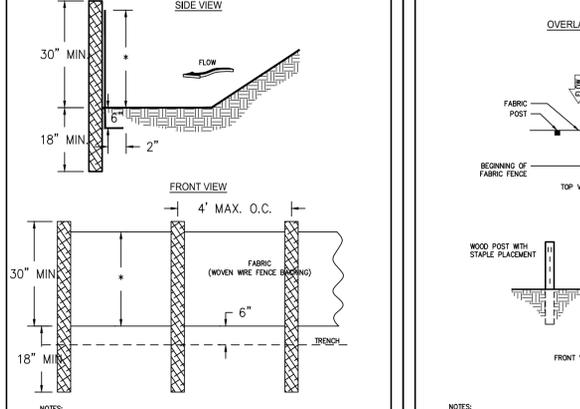

- NOTES:**
- USE STEEL OR WOOD POSTS OR AS SPECIFIED BY THE EROSION, SEDIMENTATION, AND POLLUTION CONTROL PLAN.
 - HEIGHT (H) IS TO BE SHOWN ON THE EROSION, SEDIMENTATION, AND POLLUTION CONTROL PLAN.


MAINTENANCE
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DISTURBED AREA STABILIZATION (WITH SILT FENCE)

(NTS)

Sd1-S

FASTENERS FOR SILT FENCES

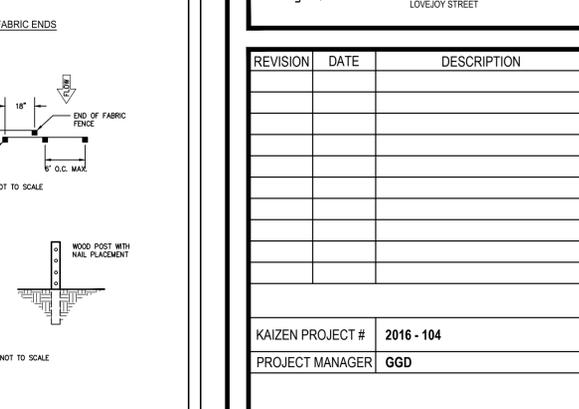

- NOTES:**
- THE FABRIC AND WIRE SHOULD BE SECURELY FASTENED TO POSTS AND FABRIC ENDS MUST BE OVERLAPPED A MINIMUM OF 18' OR WRAPPED TOGETHER AROUND A POST TO PROVIDE A CONTINUOUS FABRIC BARRIER AROUND THE INLET.

MAINTENANCE
Sediment shall be removed once it has accumulated to one-half the original height of the barrier. Filter fabric shall be replaced whenever it has deteriorated to such an extent that the effectiveness of the fabric is reduced (approximately six months). Temporary sediment barriers shall remain in place until disturbed areas have been permanently stabilized. All sediment accumulated at the barrier shall be removed and properly disposed of before the barrier is removed.


DISTURBED AREA STABILIZATION (WITH SILT FENCE)

(NTS)

Sd1-S

KAIZENCOLLABORATIVE
2390 Main Street | Tucker, GA 30084 | 404.239.2521

RUSSELL DAVIS & ASSOCIATES, INC.
CIVIL ENGINEERING DESIGN
3469 Lawrenceville Highway, Suite 309
Tucker, Georgia 30084
(678) 935-2200
russdavispe.com

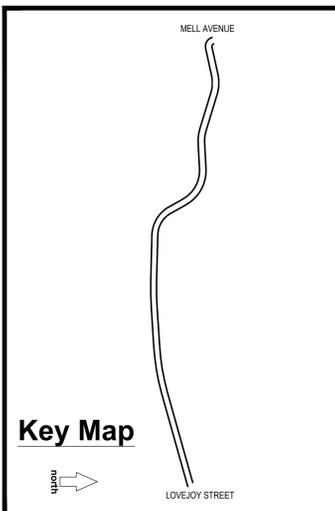

REVISION	DATE	DESCRIPTION

KAIZEN PROJECT # 2016 - 104
PROJECT MANAGER GGD

STONE MOUNTAIN PATH

CLARKSTON, GA

CONSTRUCTION DETAILS

SCALE: 1"=30'
DATE: AUG 1, 2017
SHEET NAME: ECD-03

811 UTILITIES PROTECTION CENTER, INC.
Call 811 or toll-free 800-282-7411 throughout Georgia.
Outside Georgia call 770-623-4344 prior to all construction activities.
THE LOCATION OF UTILITIES ARE SHOWN FROM FIELD EVIDENCE.
OTHER UTILITIES MAY BE PRESENT THAT ARE NOT SHOWN.
BEFORE CONSTRUCTION IT IS RECOMMENDED THAT A PRIVATE UTILITY LOCATOR INVESTIGATE ALL UNDERGROUND UTILITIES.

GSWCC
Georgia Storm Water Management Commission
Russell Davis #24598
Expires 12/01/2018

